ABBREVIATIONS

	<u> </u>		 	
	ADJ	ADJUSTABLE	SF	SQUARE FOOT
3		APPROXIMATE	SHT	SHEET
	CAB	CABINET	SIM	SIMILAR
			51M	STAINLESS STEEL
	CLG	CEILING		
4	CONC	CONCRETE	STL	STEEL
	CONT	CONTINUOUS	TOC	TOP OF CONCRETE
	CJ	CONSTRUCTION JOINT	TOM	TOP OF MASONRY
	DIA	DIAMETER	TYP	TYPICAL
	DWG	DRAWING	VIF	VERIFY IN FIELD
	E6B	EQUIPMENT GROUND BAR	UON	UNLESS OTHERWISE NOTED
À	EA	EACH	MMF	WELDED WIRE FABRIC
•	ELEC	ELECTRICAL	W	MITH
:	EL	ELEVATION	BTS	BASE TRANSMISSION
1	EQ	EQUAL		STATION
	EQUIP	EQUIPMENT	PCS	PERSONAL
	EXT	EXTERIOR	105	COMMUNICATIONS
	FF	FINISHED FLOOR		SERVICES
	GA	GAUGE		
13	GALV	GALVANIZED	A-I	ANTENNA MARK NO.
Ų.	GC	GENERAL CONTRACTOR	Q.	CENTERLINE
3	GRND	GROUND	Ł	OLIVILINL
	LG	LONG	P	PLATE
3	MAX	MAXIMUM		4115
. 9	MECH	MECHANICAL	4 ° ,	AND
	MFR	MANUFACTURER	@	AT .
	MGB	MASTER GROUND BAR		
		5.415.115.416.2		


MINIMUM

METAL

OPPOSITE

NOT IN CONTRACT NOT TO SCALE ON CENTER

SYMBOLS AND MATERIALS

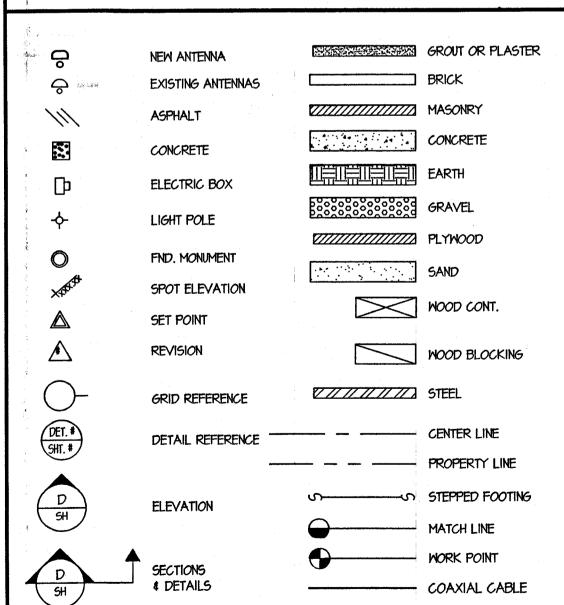

CONTRACTOR SHALL REFER TO PRIMECO'S DETAILED SPECIFICATIONS FOR CELL SITES FOR ANY ITEMS OR WORK NOT LISTED OR DETAILED HEREON.
STANDARD SPECIFICATIONS SHALL SUPERCEDE WHERE CONFLICTS OCCUR.



PRIMECO


SOUTH CENTRAL DECATUR

PERSONAL COMMUNICATIONS

CLARKSON GRAIN COMPANY S. BROADWAY, DECATUR, IL 62521

CGB 3614-7

PROPOSED COMMUNICATION SITE WITH 150' MONOPOLE AND 8'x12' EQUIPMENT SHELTER

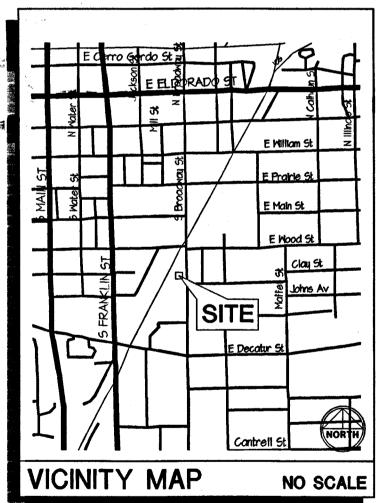

SITE NUMBER: CGB 3614-7 SITE NAME: SOUTH/CENTRAL DECATUR SITE ADDRESS: CLARKSON GRAIN COMPANY SOUTH BROADWAY DECATUR, IL 62521 PROPERTY OWNER: CLARKSON GRAIN COMPANY LOT NUMBER: 19 IN A.G. WEBBERS SUBDIVISION BLOCK NUMBER: N/A APPLICANT: PRIMECO PERSONAL COMMUNICATIONS, L.P. ONE PIERCE PLACE, SUITE 1100 ITASCA, ILLINOIS 60143 CONTACT PERSON: JOE PECKENS CONTACT PHONE NO.: (630) TT3-1600 ASSESSOR'S PARCEL NO.: 04-12-14-307-017 PROJECT SUMMARY

	SHT. NO.	DESCRIPTION	REV. NO.
ed .	, T-1	TITLE SHEET	
	L5-I	SITE SURVEY	
96. 965.	Z-I	SITE PLAN	
	Z-2	ELEVATIONS	
	A-I	SITE PLAN, AND PROJECT NOTES	
	A-2	ANTENNA LOCATION PLAN, SECTIONS	
20		AND ELEVATIONS	
	A-3	SECTIONS	
此	5-1	SCREW ANCHOR FOUNDATION SECTIONS,	
And And And And And And And And And And		AND DETAILS	
	E-I	ELECTRICAL PLAN, RISER, NOTES, DETAILS	
35	E-2	GROUNDING RISER AND DETAILS	
	E-3	ELEVATIONS, AND ANTENNA SCHEDULE	
	SH	EET INDEX	

DRIVING DIRECTIONS

FROM PRIMECO OFFICES IN ITASČA:

INTERSECTION OF 72 WEST AND 51 SOUTH. GO SOUTH ON 51 APPROXIMATELY 5 MILES TO WOOD ROAD. GO EAST ON WOOD APPROXIMATELY 0.3 MILE TO MARTIN LUTHER KING JR. DR. GO SOUTH ON MARTIN LUTHER KING JR. DR. APPROXIMATELY 200' TO SITE. THE SITE IS LOCATED ON THE WEST SIDE OF THE STREET BETWEEN GRAIN ELEVATOR AND RADIATOR SHOP.

CONTRACTOR SHALL VERIFY ALL PLANS AND EXISTING DIMENSIONS AND CONDITIONS ON THE JOB SITE AND SHALL IMMEDIATELY NOTIFY THE ARCHITECT IN WRITING OF ANY DISCREPANCIES BEFORE PROCEEDING WITH THE WORK OR BE RESPONSIBLE FOR SAME

PROFES	SIONAL	ENGINEER	3
		ont many mindrate Server, most protection, proprietables his transfer de provincien	

W-T		1	
Y-T ENGINEERING, INC.			
LICENSED PROFESSIONAL	ENGINEER	R - STATE	OF ILLINOIS
SCOTT	R. TRIP	HAHN	

SIGNED: / /

EXPIRES: 11/30/97



ONE PIERCE PLACE SUITE 1100 ITASCA, ILLINOIS 60143 OFFICE: (630) 773-1600 FAX: (630) 285-1580

APPROVALS	
PRIMECO	
LANDLORD	·
LEASING	
R.F	
ZONING	
CONSTRUCTION	
BSIE	

	11100201110	10/1/0
	DRAWN BY	CDG
1		

l	CHECKED	ВΥι	KMM
I			
l			

		4.
2	8-12-97	PER REVISED
1	6-24-97	FOR CONSTRUCTION



W-T ENGINEERING, INC

39 EAST SCULLY DRIVE SCHAUMBURG, ILLINOIS 60193 ph. (847) 895-3640 fax. (847) 895-9985

CGB 3614-7 SOUTH/CENTRAL DECATUR

CLARKSON GRAIN COMPANY SOUTH BROADWAY DECATUR, IL


SHEET TITLE


TITLE SHEET

T-1

EXHIBITA

SHEET NUMBER

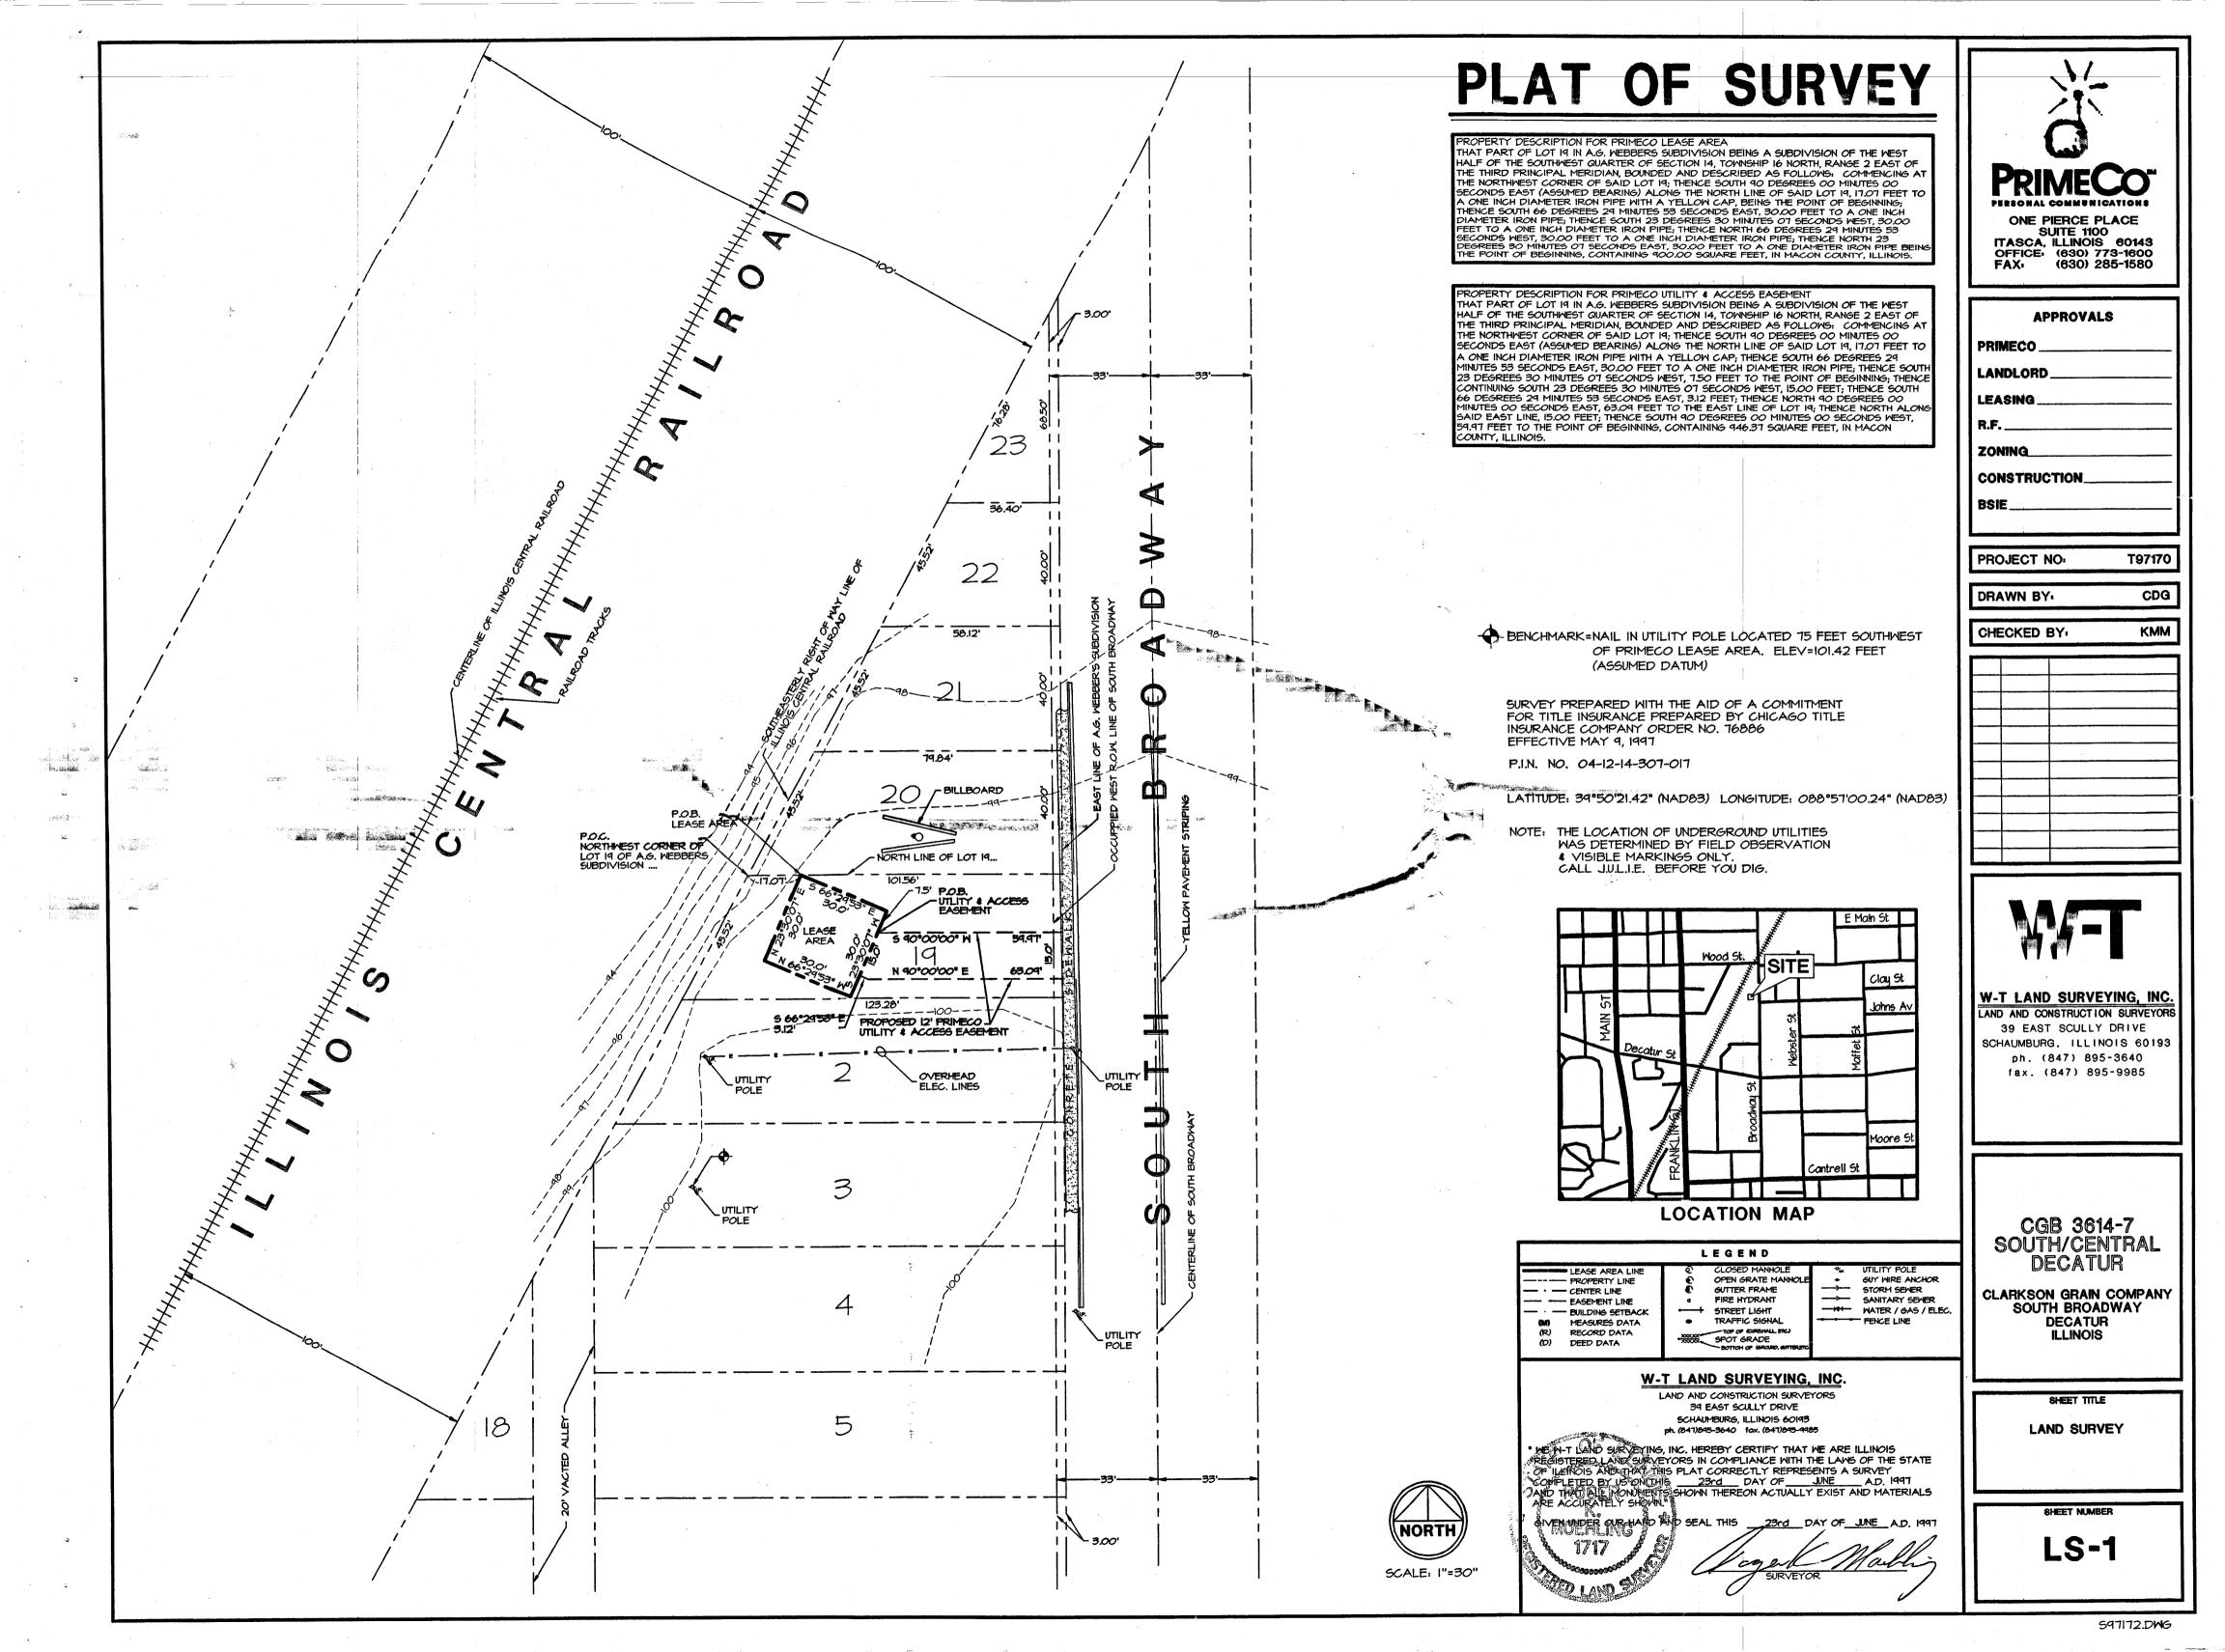

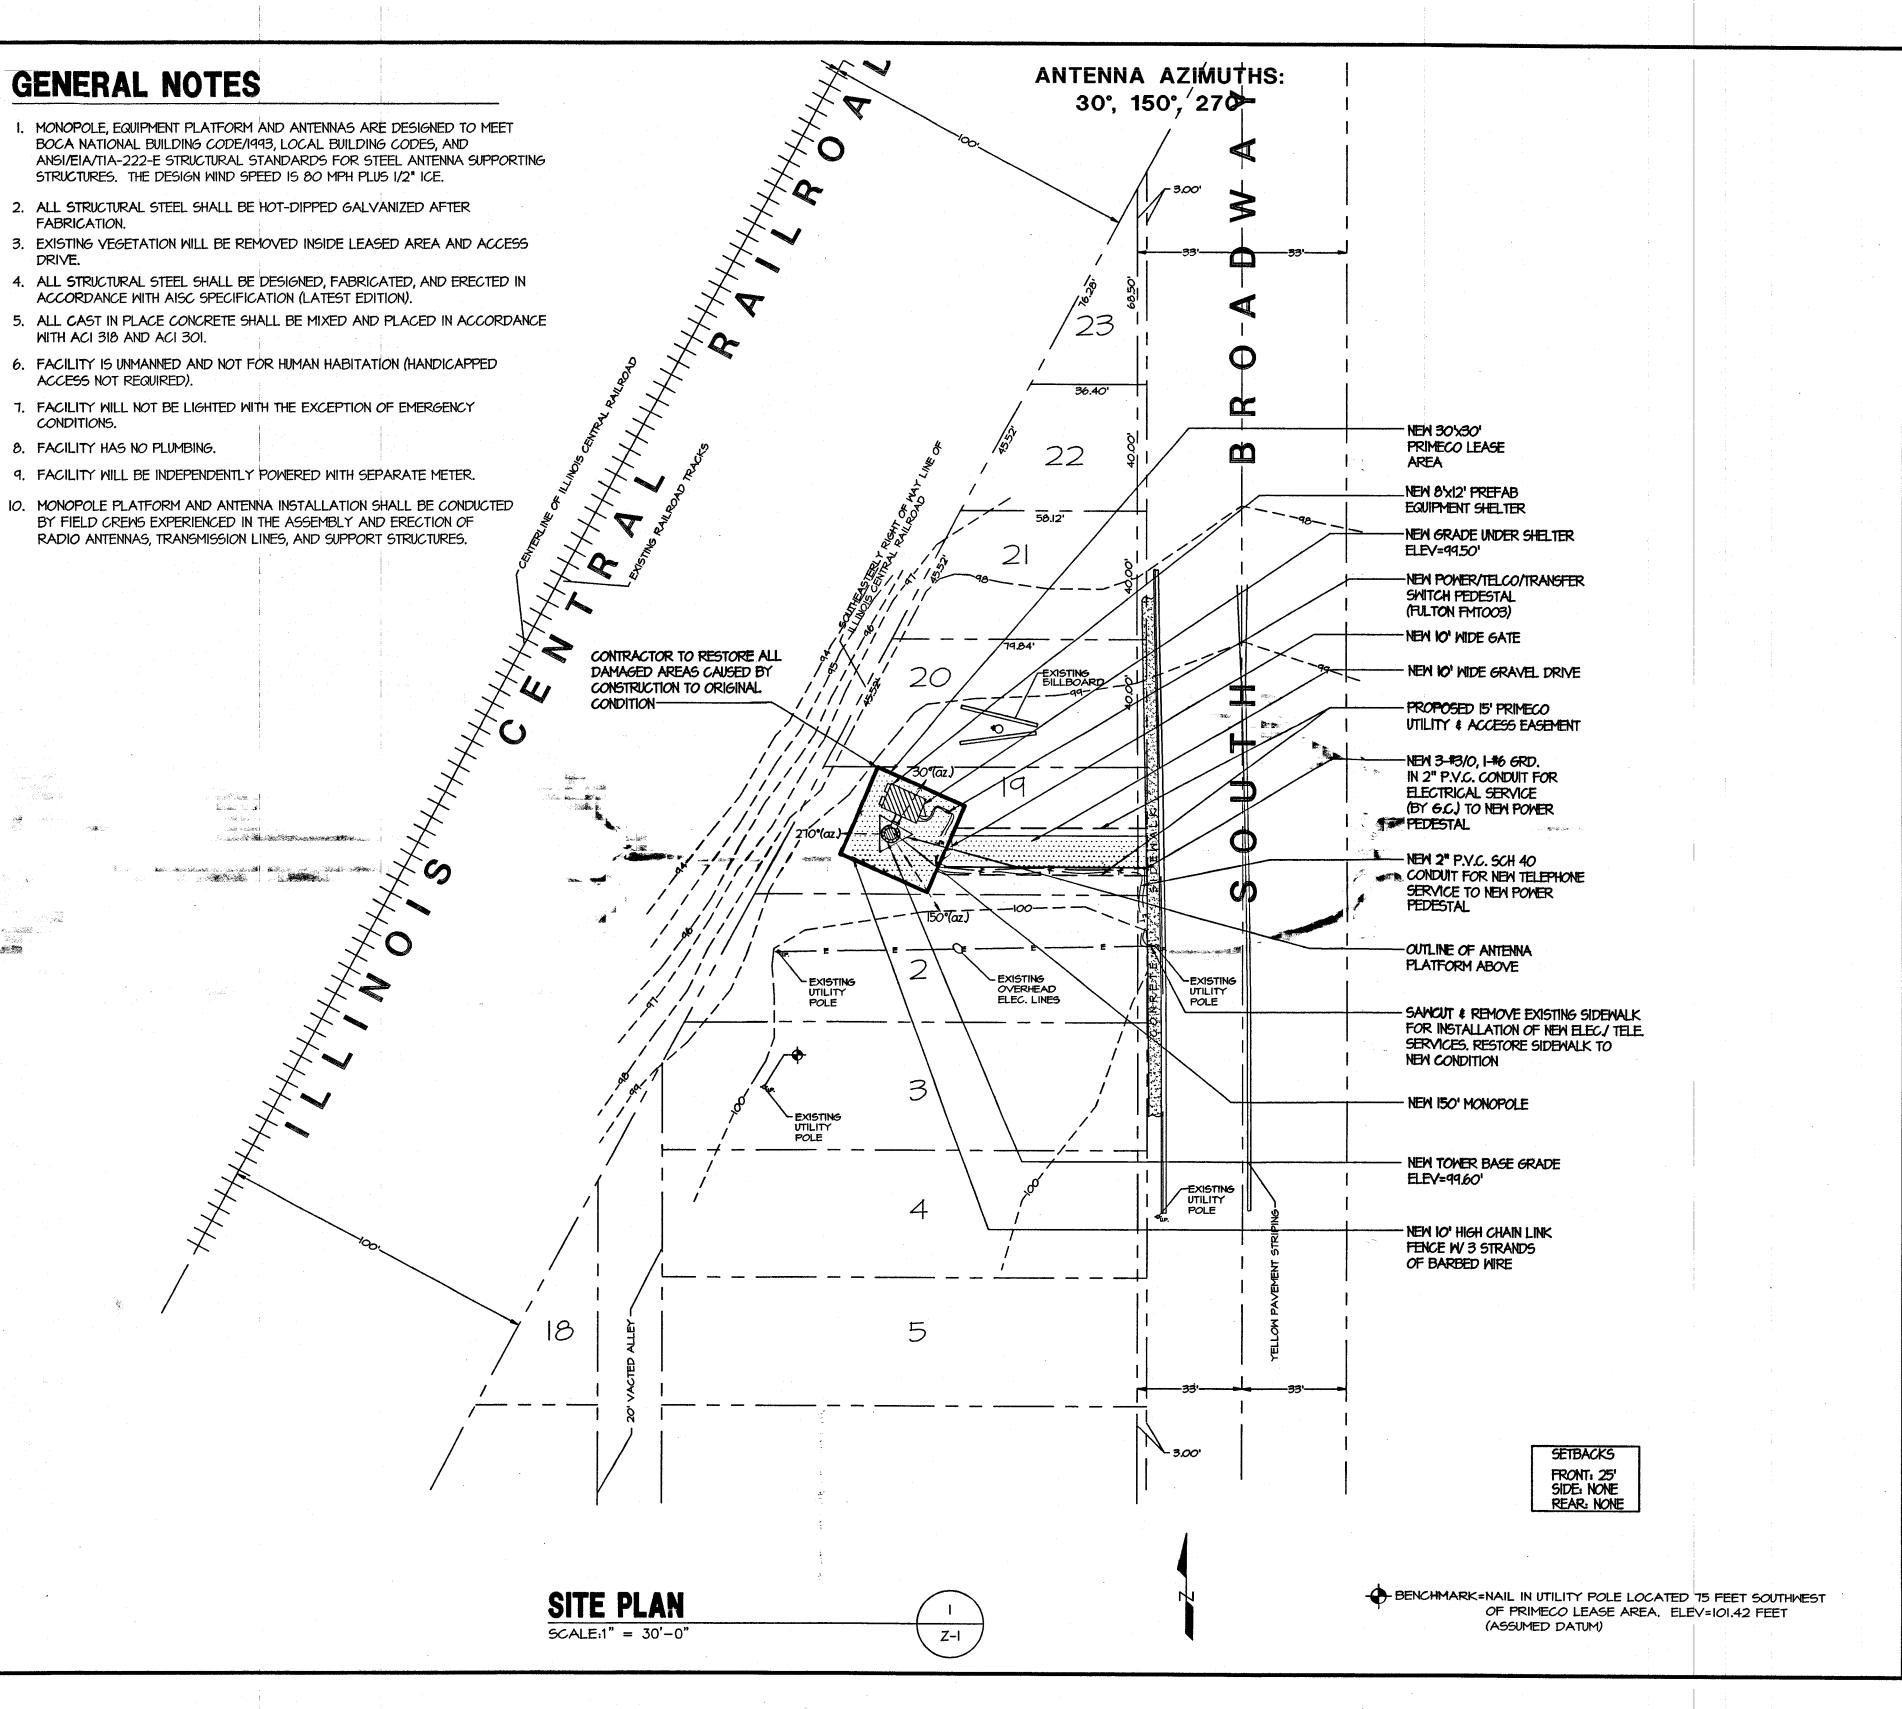



ONE PIERCE PLACE SUITE 1100 ITASCA, ILLINOIS 60143 OFFICE: (630) 773-1600 FAX: (630) 285-1580

APPROVALS	
PRIMECO	
LANDLORD	_
LEASING	_
R.F	_
ZONING	_
CONSTRUCTION	
BSIE	_

CHECKED BY: KMM

T97170

PROJECT NO

2 8-12-97 PER REVISED
1 6-24-97 FOR CONSTRUCTION



W-T ENGINEERING, INC.
CONSULTING ENGINEERS

39 EAST SCULLY DRIVE SCHAUMBURG. ILLINOIS 60193 ph. (847) 895-3640 fax. (847) 895-9985

CGB 3614-7 SOUTH/CENTRAL DECATUR


CLARKSON GRAIN COMPANY SOUTH BROADWAY DECATUR, IL

SHEET TITLE

SITE PLAN

SHEET NUMBER

Z-1

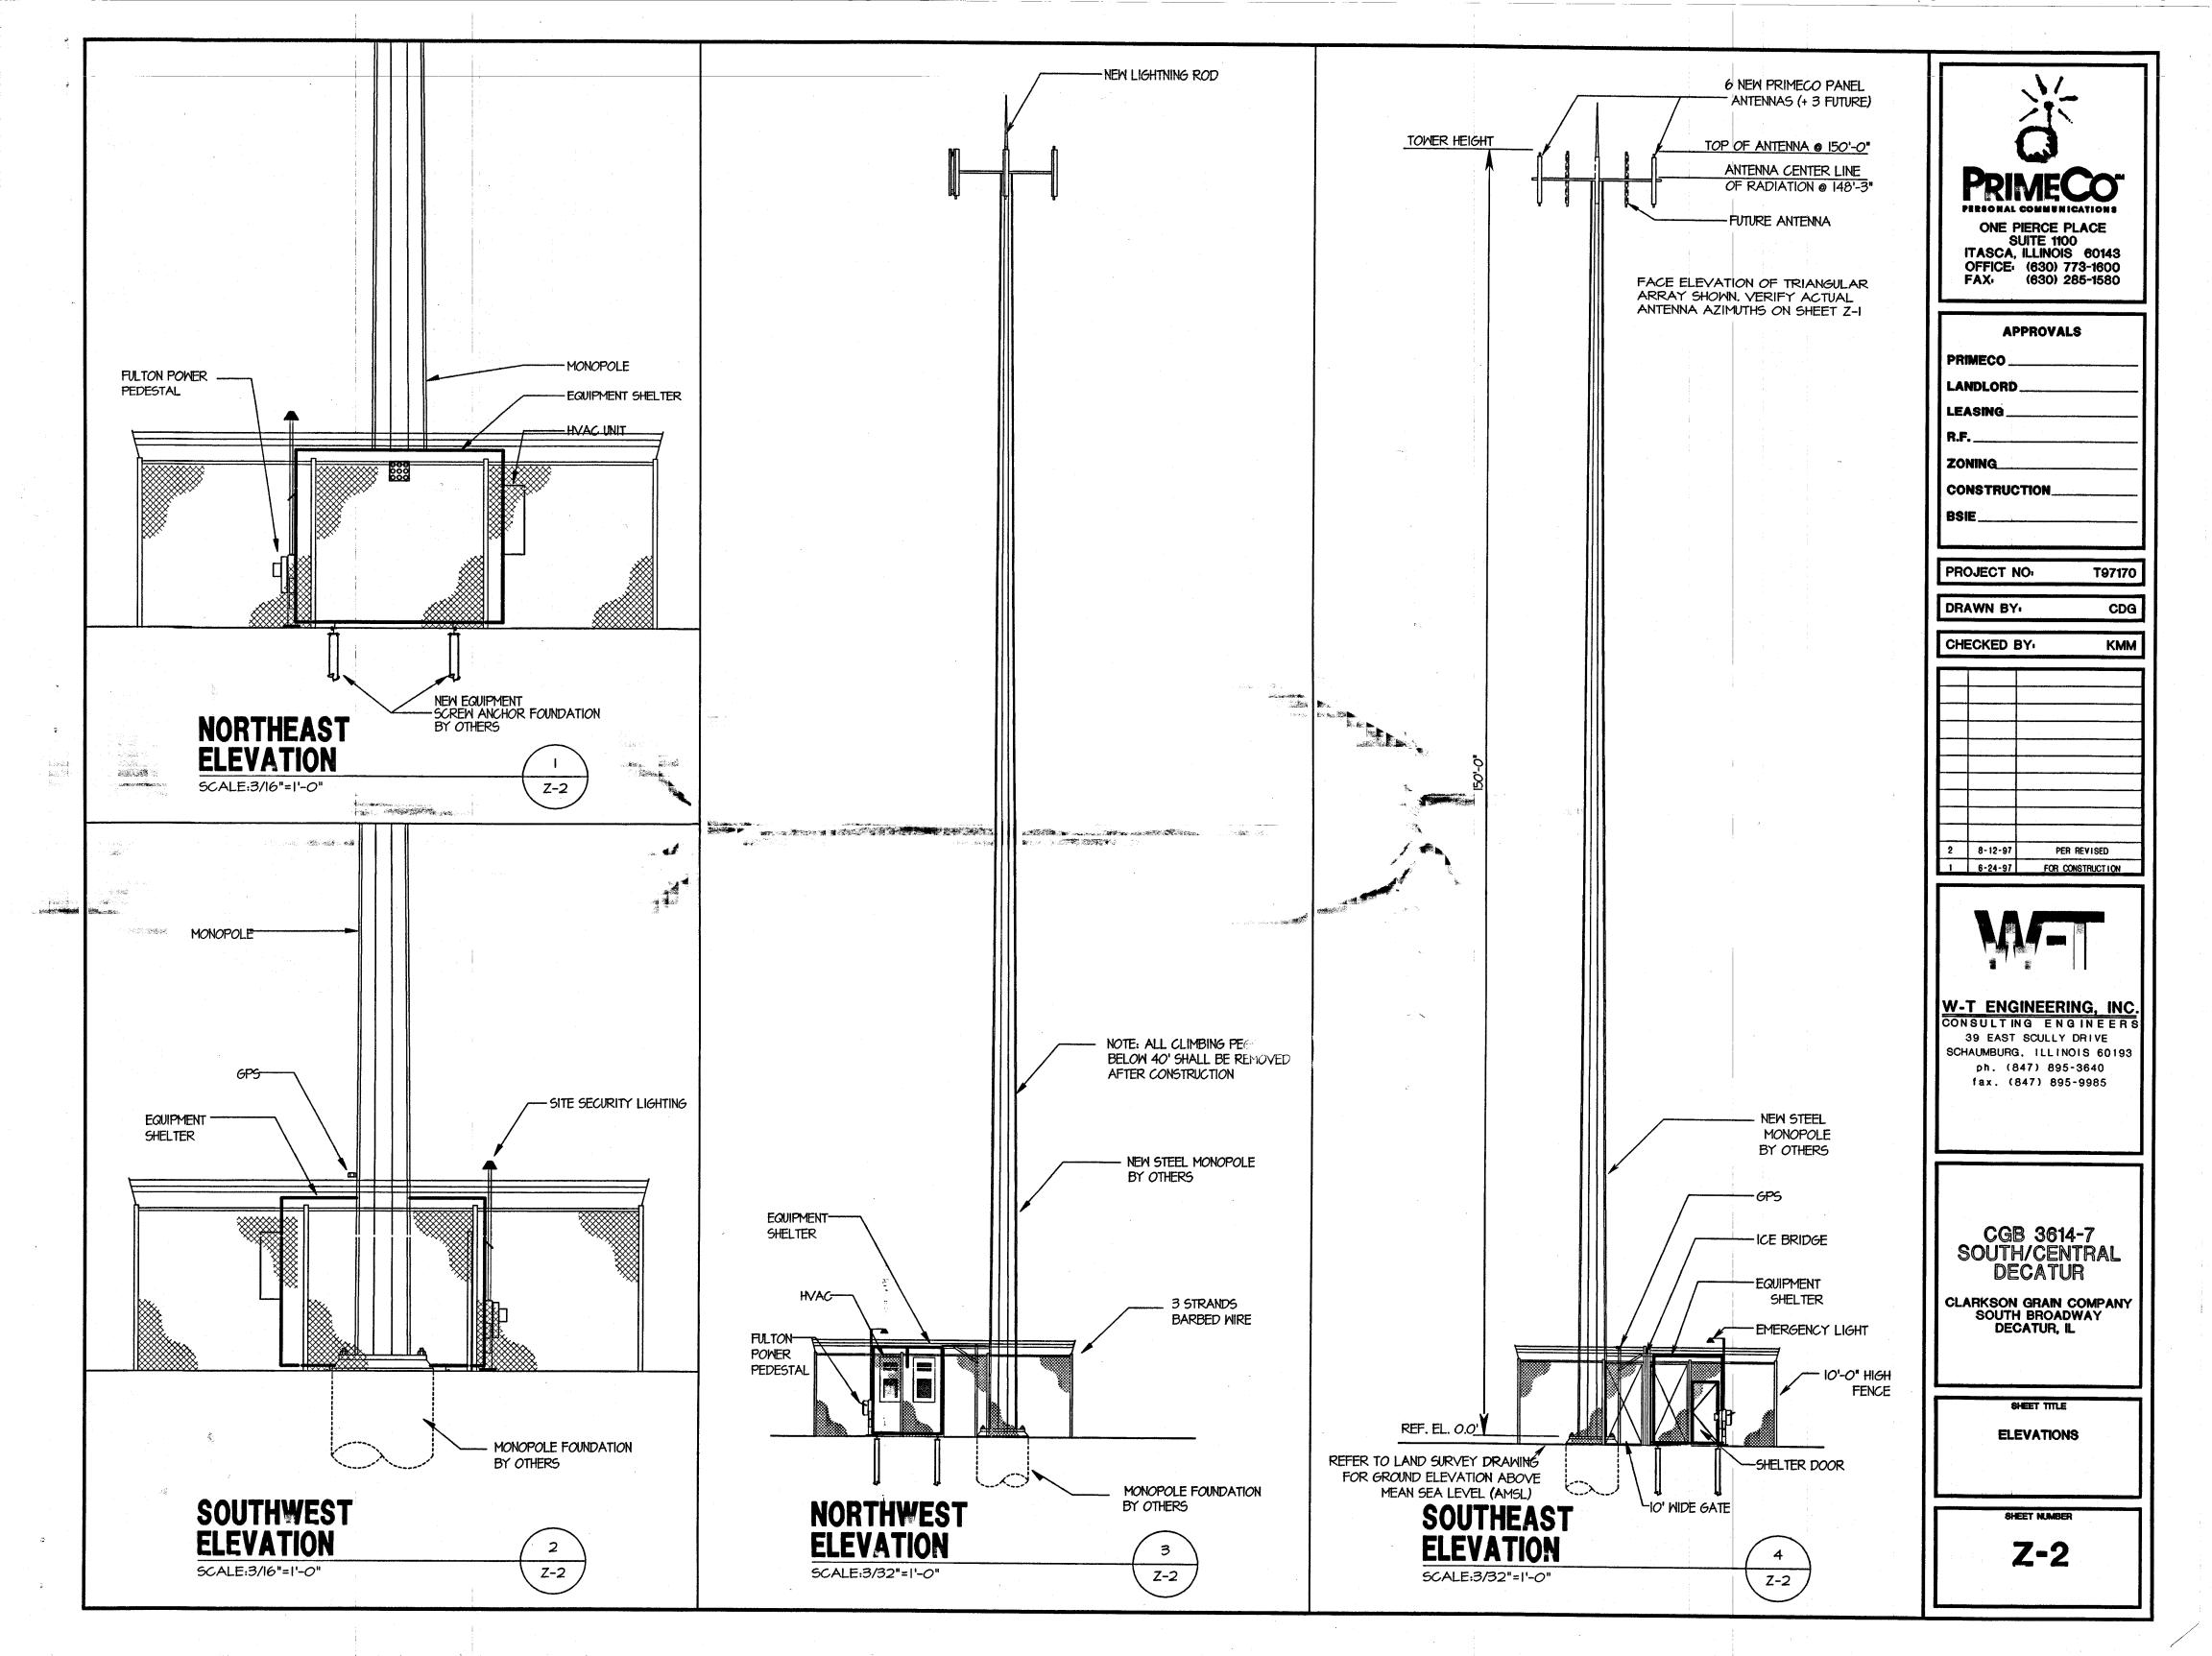


PROJECT NOTES

- I. THE GENERAL CONTRACTOR AND OR HIS SUBCONSULTANT SHALL BE RESPONSIBLE FOR OBTAINING ALL PERMITS AND INSPECTIONS WHICH MAY BE REQUIRED FOR THE WORK BY THE ARCHITECT/ENGINEER, THE STATE, COUNTY OR LOCAL GOVERNMENT AUTHORITY.
- 2. REFER TO THE SITE PLAN PREPARED BY OTHERS FOR BOUNDARY SURVEY AND SITE TOPOGRAPHY.
- 3. DESIGN REQUIREMENTS FOR THE ANTENNA SUPPORTING STRUCTURE ARE PER BOCA NATIONAL BUILDING CODE/1993, LOCAL BUILDING CODES, AND THE EIA/ TIA-222-E STRUCTURAL STANDARDS FOR STEEL ANTENNA SUPPORTING STRUCTURES. THE BASIC WIND SPEED UTILIZED FOR DESIGN IS 80 MPH PLUS I/2" ICE.
- 4. CONCRETE FOR FENCE POST AND ICEBRIDGE SUPPORT SHALL BE 3000 PSI AIR ENTRAINED (4%-6%) NORMAL WEIGHT CONCRETE.
- 5. FENCED SITE AREA SHALL BE CLEARED AND GRUBBED. REMOVE UNSUITABLE SOFT OR LOOSE SOILS, ORGANIC MATERIAL AND OR RUBBLE TO FIRM SUBGRADE AS APPROVED BY GEOTECHNICAL REPORT. PLACE A MIRAFI 500X SHEET ON SUBGRADE AND FILL WITH 4 INCHES OF AASHTO 57 STONE TO FINISH GRADE.
- 6. STRUCTURAL STEEL SHALL CONFORM TO LATEST EDITION OF THE AISC SPECIFICATION FOR STRUCTURAL STEEL BUILDINGS- ALLOWABLE STRESS DESIGN AND PLASTIC DESIGN INCLUDING THE COMMENTARY AND THE CODE OF STANDARD PRACTICE.
- 7. STRUCTURAL STEEL PLATES AND SHAPES SHALL CONFORM TO ASTM A36.
 ALL STRUCTURAL STEEL PIPES SHALL CONFORM TO ASTM A53 GRADE B.
 ALL STRUCTURAL STEEL COMPONENTS AND FABRICATED ASSEMBLIES SHALL BE HOT DIP GALVANIZED AFTER FABRICATION.
- 8. WELDING SHALL BE IN ACCORDANCE WITH THE AMERICAN WELDING SOCIETY (AWS) D.I.I-92 STRUCTURAL WELDING CODE- STEEL WELD ELECTRONICS SHALL BE ETOXX.
- 9. ALL THREADED STRUCTURAL FASTENERS FOR ANTENNA SUPPORT ASSEMBLIES SHALL CONFORM TO ASTM A325. FASTENERS SHALL BE 5/8" MINIMUM DIAMETER BEARING TYPE CONNECTIONS WITH THREADS INCLUDED IN THE SHEAR PLANE. ALL EXPOSED FASTENERS, NUTS AND WASHERS SHALL BE GALVANIZED UNLESS OTHERWISE NOTED. CONCRETE EXPANSION ANCHORS SHALL BE HILTI KWIK BOLTS UNLESS OTHERWISE NOTED.
- IO. ALL COAXIAL CABLE CONNECTORS AND TRANSMITTER EQUIPMENT SHALL BE AS SPECIFIED BY THE OWNER. THE CONTRACTOR SHALL FURNISH ALL CONNECTION HARDWARE REQUIRED TO SECURE THE CABLES.
- II. STEEL FENCE SYSTEM SHALL INCLUDE THE FENCE POSTS, FABRIC, GATE SYSTEM AND ALL NECESSARY ERECTION ACCESSORIES, FITTINGS, AND FASTENINGS. ALL FENCE SYSTEM COMPONENTS SHALL BE GALVANIZED IN ACCORDANCE WITH ASTM AIS3. GATES SHALL BE SWING GATES WITH 4'-O" LEAFS. REFER TO TYPICAL FENCE DETAILS AND SPECIFICATIONS FOR ADDITIONAL INFORMATION. INSTALL FENCE AFTER CONCRETE HAS ATTAINED 15% OF 28 DAY DESIGN STRENGTH.
- 12. NORTH ARROW SHOWN ON PLANS REFERS TO TRUE NORTH. CONTRACTOR SHALL VERIFY TRUE NORTH AND INFORM CONSTRUCTION MANAGER OF ANY DISCREPANCIES BEFORE STARTING CONSTRUCTION.

REFER TO E-I SHEET FOR SITE ELECTRICAL DIAGRAM, DETAILS AND LAYOUT

BUILDING / SHELTER FOUNDATION DESIGN IS UNDER SEPERATE CONTRACT BY OTHERS AND IS EXCLUDED FROM THESE DESIGN DRAWINGS, REFER TO OWNER PROVIDED DRAWINGS FOR SPECIFIC DETAILS REGARDING FOUNDATION SYSTEM.

MONOPOLE / TOWER FOUNDATION DESIGN IS UNDER SEPERATE CONTRACT BY OTHERS
AND IS EXCLUDED FROM THESE DESIGN DRAWINGS, REFER TO OWNER PROVIDED DRAWINGS P
FOR SPECIFIC DETAILS REGARDING FOUNDATION SYSTEM.

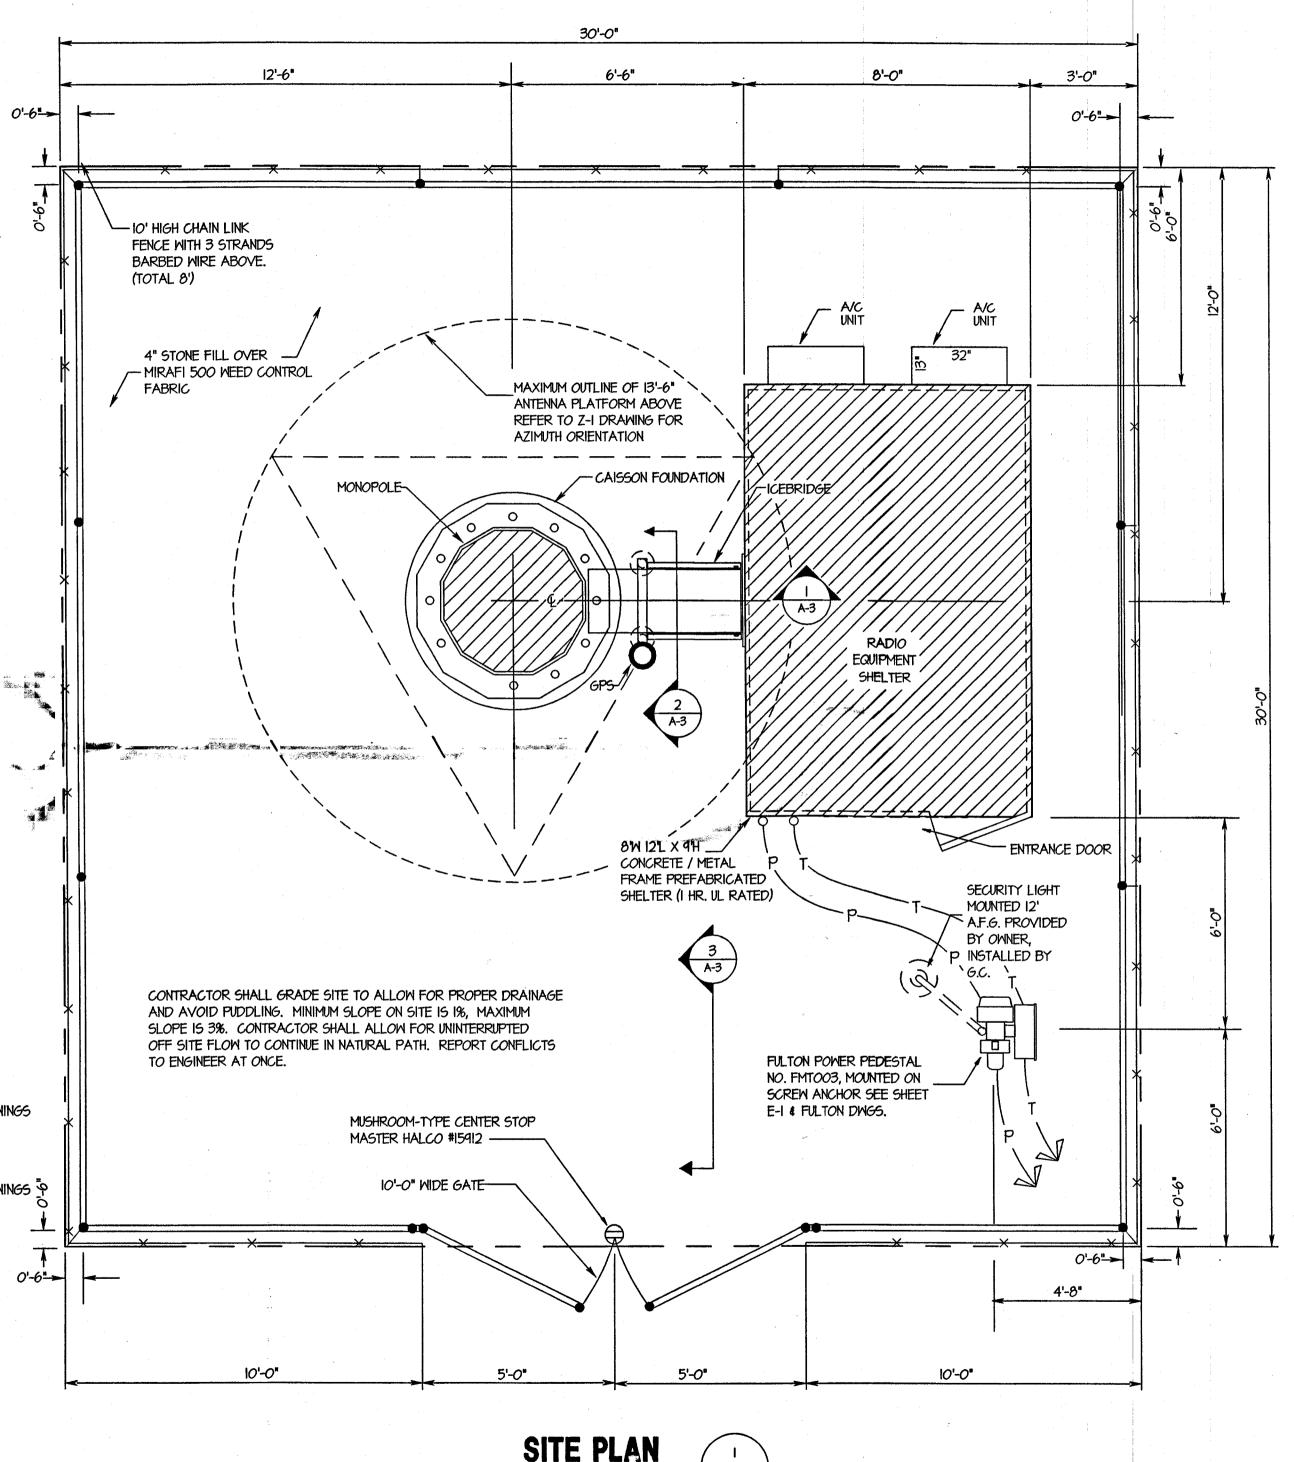

SCALE:3/8"=1'-0"



OFFICE: (630) 773-1600 FAX: (630) 285-1580

APPROVALS

PRIMECO
LANDLORD
LEASING
R.F.
ZONING
CONSTRUCTION
BSIE

PROJECT NO: T97170

DRAWN BY: CDG

KMM

CHECKED BY

2 8-12-97 PER REVISED
1 6-24-97 FOR CONSTRUCTION



W-T ENGINEERING, INC.
CONSULTING ENGINEERS
39 EAST SCULLY DRIVE
SCHAUMBURG, ILLINOIS 60193
ph. (847) 895-3640
fax. (847) 895-9985


CGB 3614-7
SOUTH/CENTRAL
DECATUR


CLARKSON GRAIN COMPANY SOUTH BROADWAY DECATUR, IL


SITE PLAN & PROJECT NOTES


SHEET NUMBER

A-1

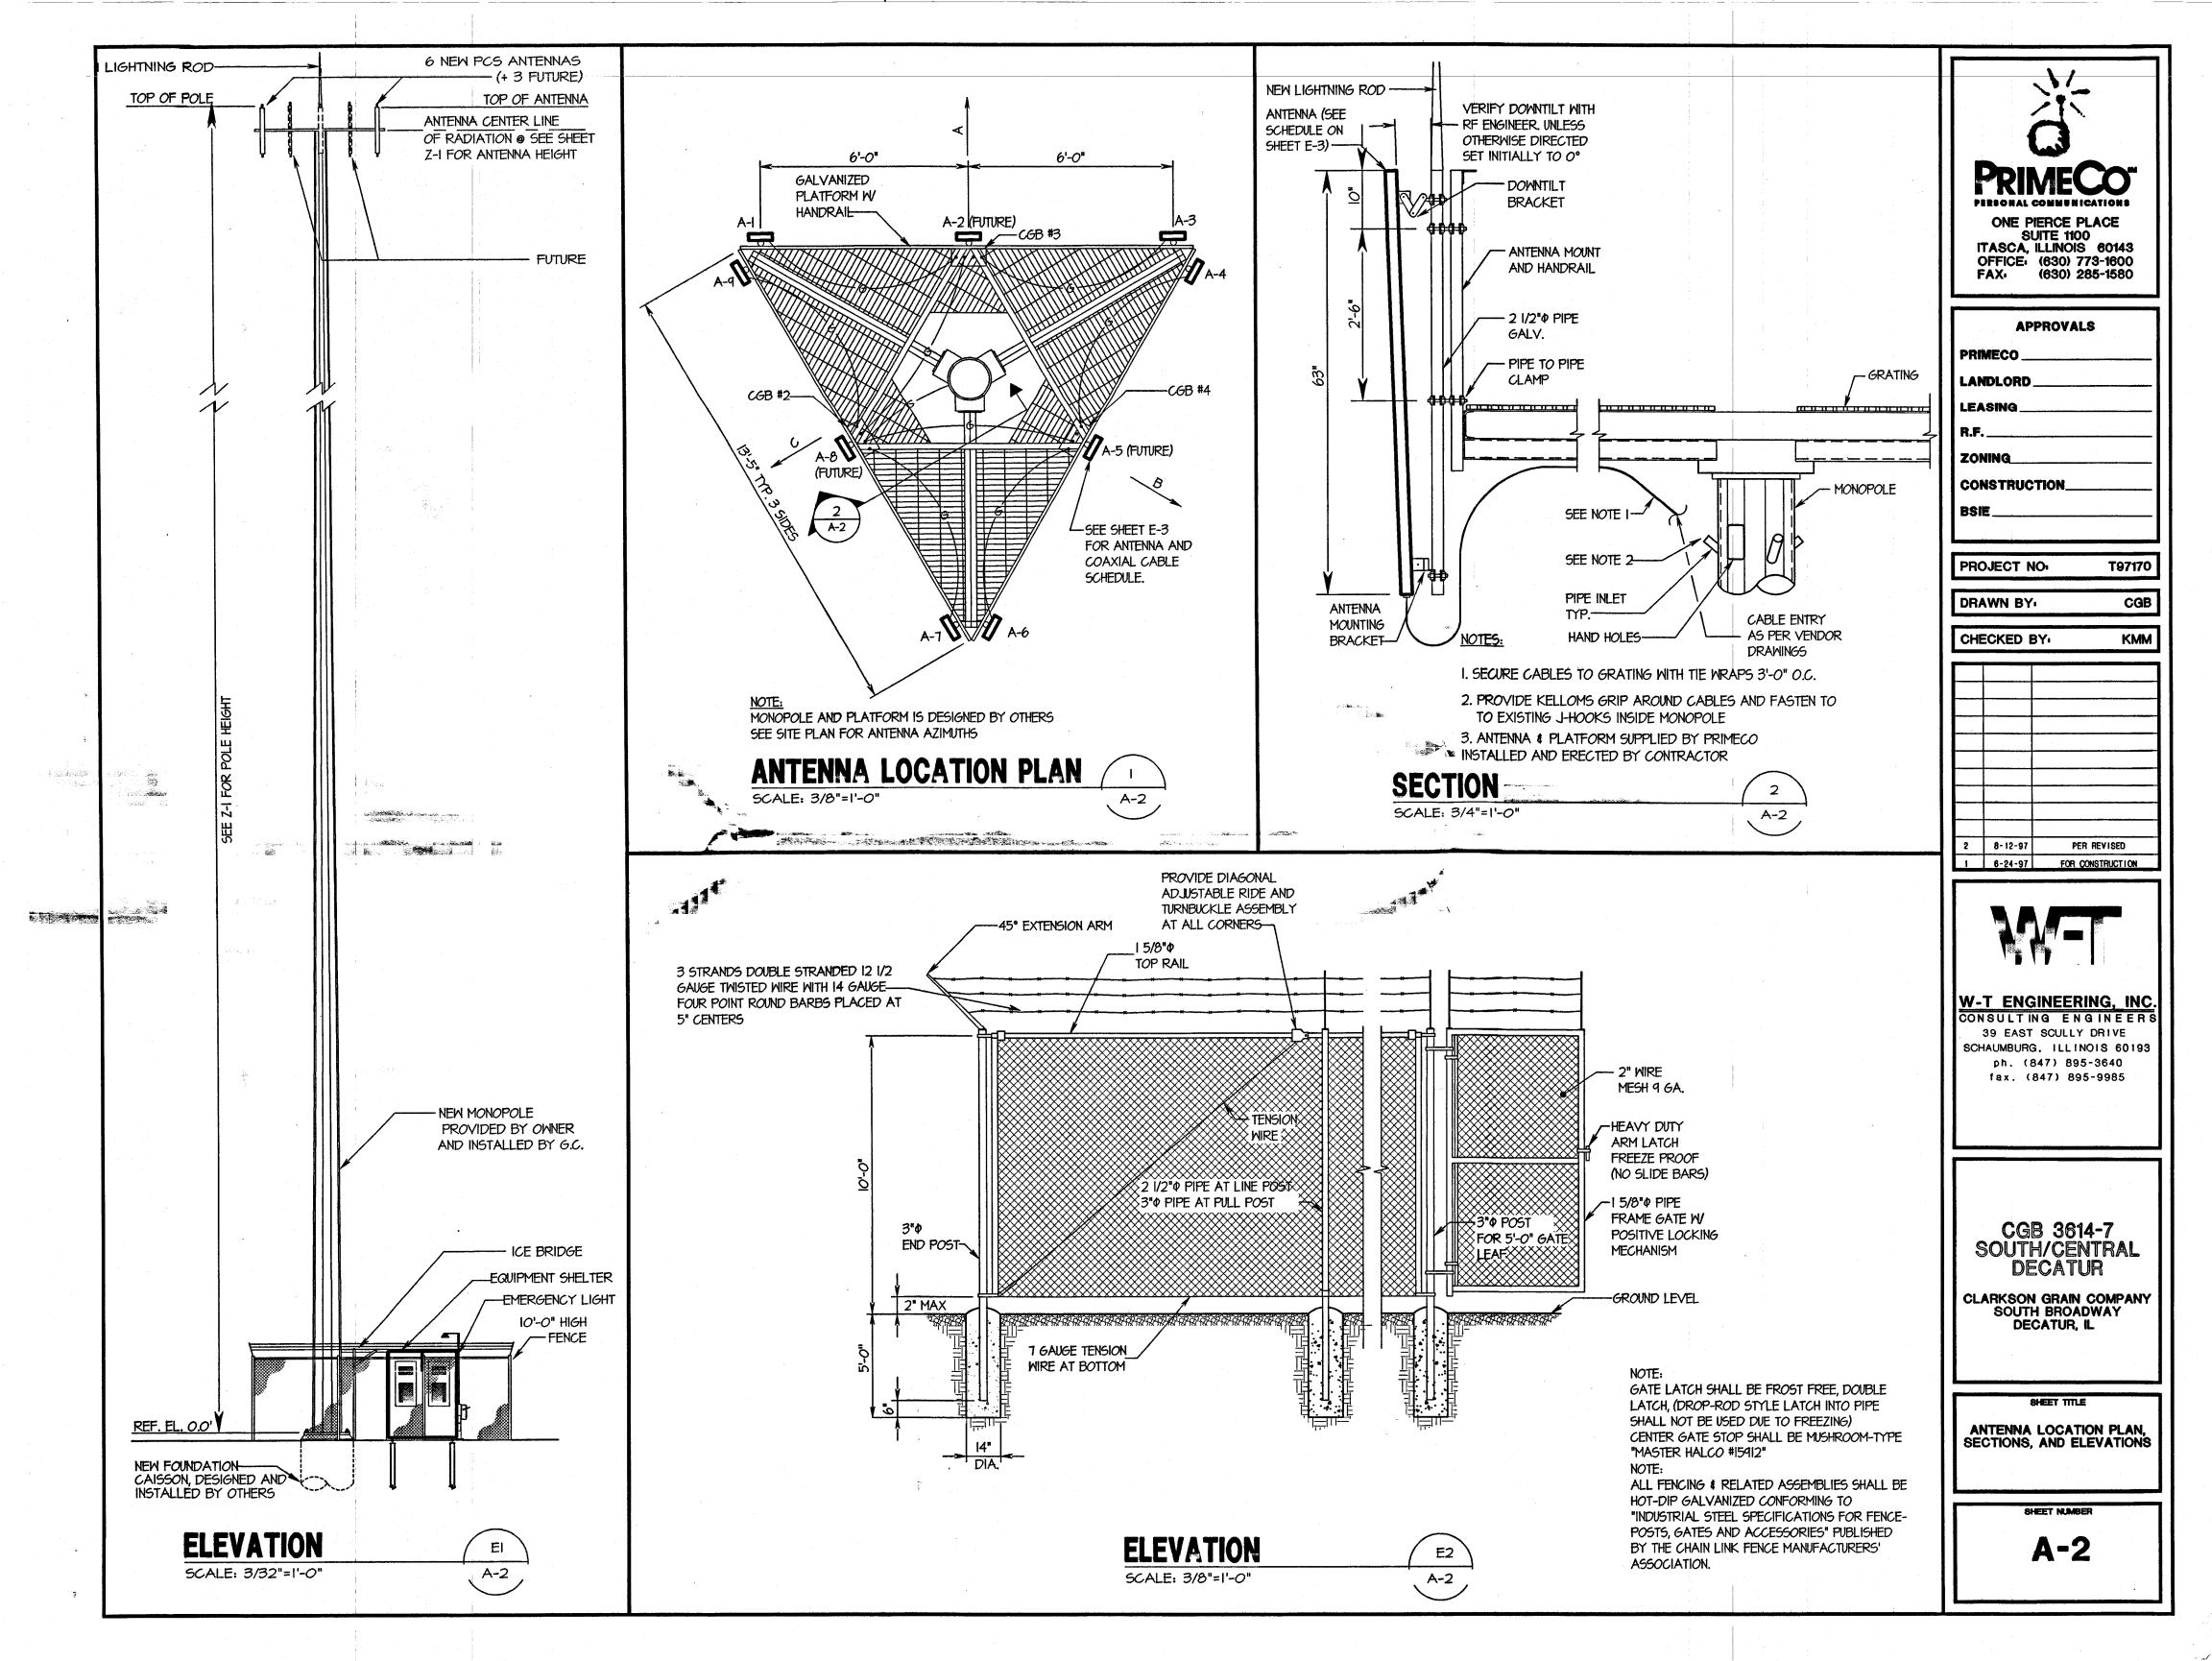

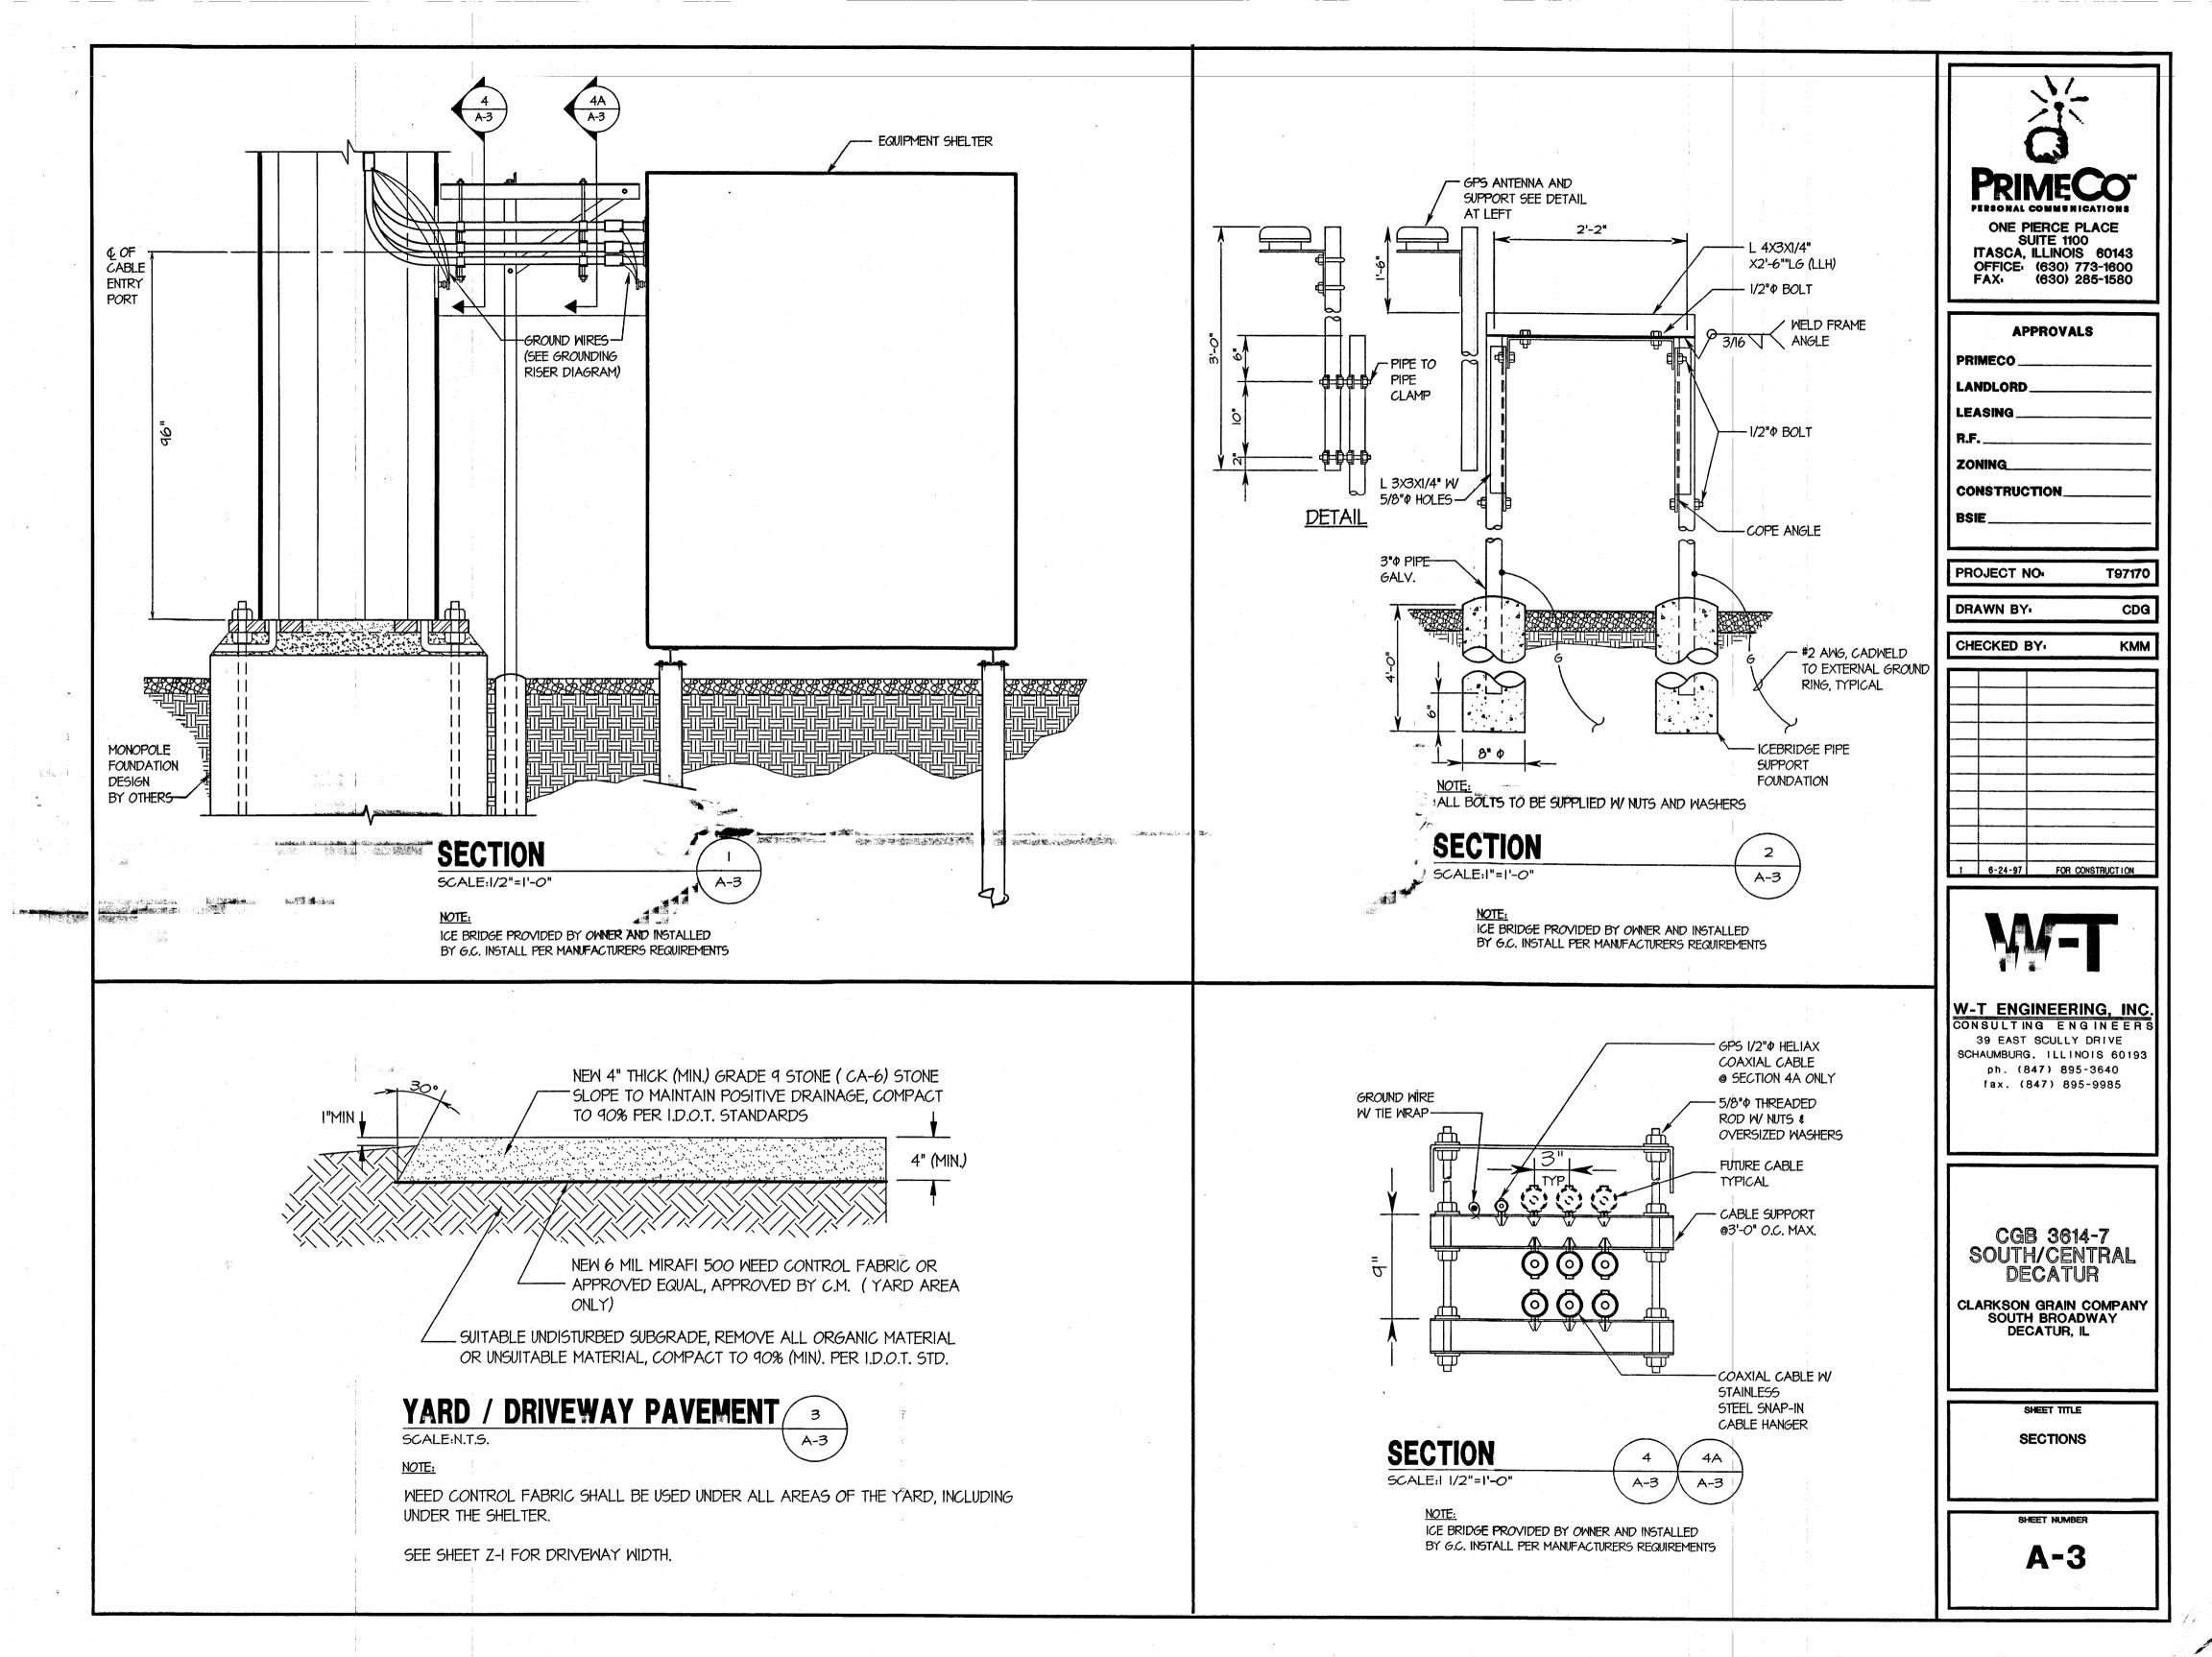

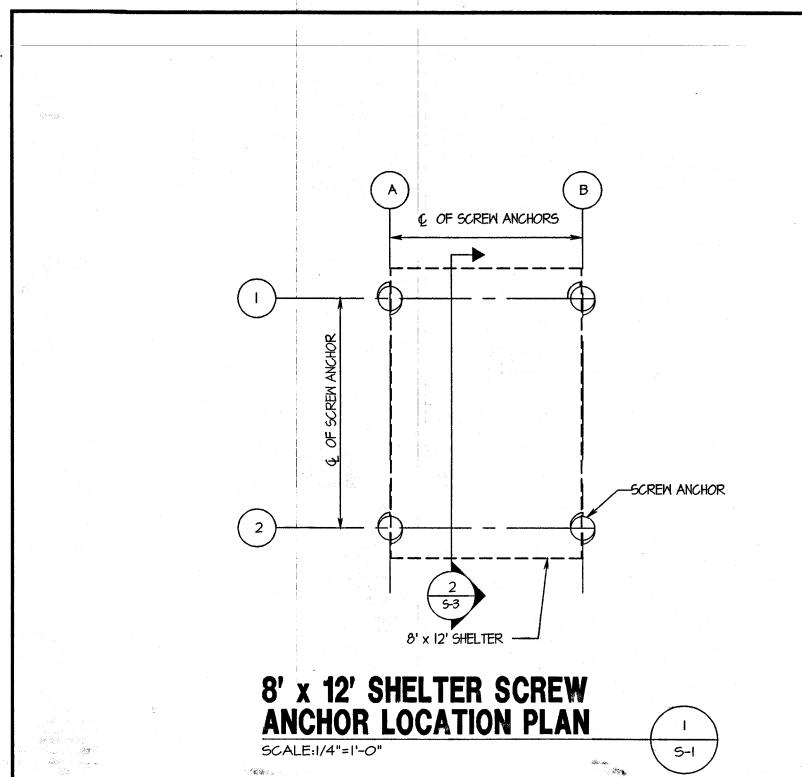

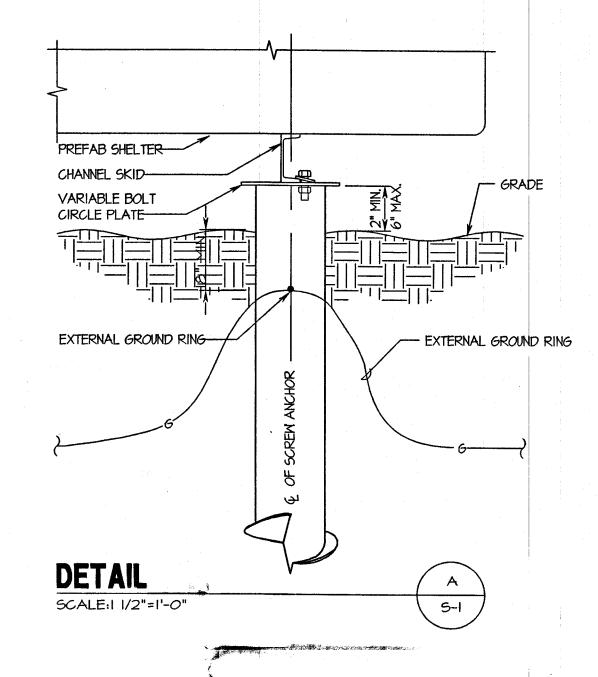

GENERAL NOTES

- I. FOUNDATION SHOWN IS FOR REFERENCE ONLY REFER TO STRUCTURAL DRAWING PROVIDED UNDER SEPERATE COYER BY OTHERS.
- 2. EXACT FOUNDATION SPECIFICATION AND ANCHOR BOLT LAYOUT SHALL BE COORDINATED WITH SHELTER MANUFACTURER.



ONE PIERCE PLACE SUITE 1100 ITASCA, ILLINOIS 60143 OFFICE: (630) 773-1600 FAX: (630) 285-1580

APPROVALS
PRIMECO
LANDLORD
LEASING
R.F
ZONING
CONSTRUCTION
BSIE
:

PROJECT NO: T97170			
PH	JJECT N	NO: T97170	
DRAWN BY: CGI			
CHE	ECKED	BY: KMM	
	<u> </u>		
•	6 04 07	COD COMOTOMOT LOW	



W-T ENGINEERING, INC

39 EAST SCULLY DRIVE SCHAUMBURG, ILLINOIS 60193 ph. (847) 895-3640 fax. (847) 895-9985

CGB 3614-7 SOUTH/CENTRAL DECATUR


CLARKSON GRAIN COMPANY SOUTH BROADWAY DECATUR, IL


SHEET TITLE


SECTIONS AND DETAILS FOR 8'X12' SCREW ANCHOR FOUNDATION

SHEET NUM

S-1

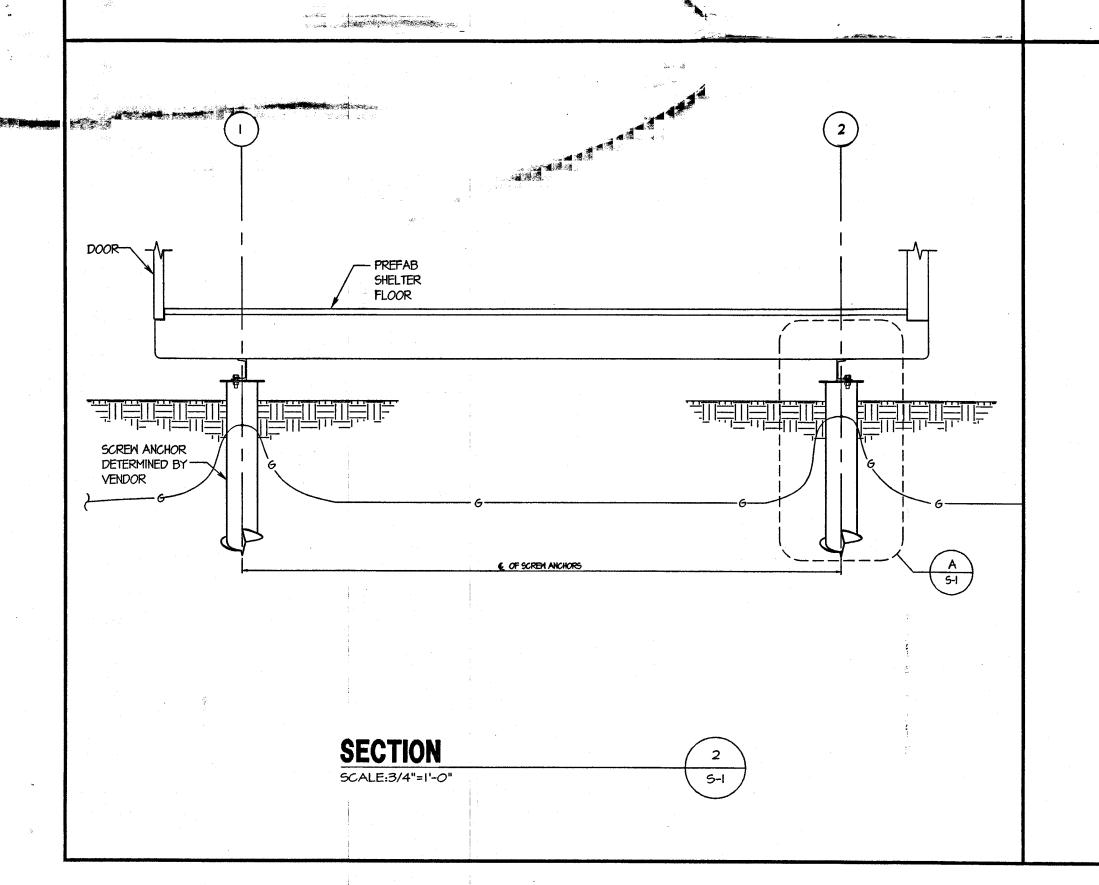

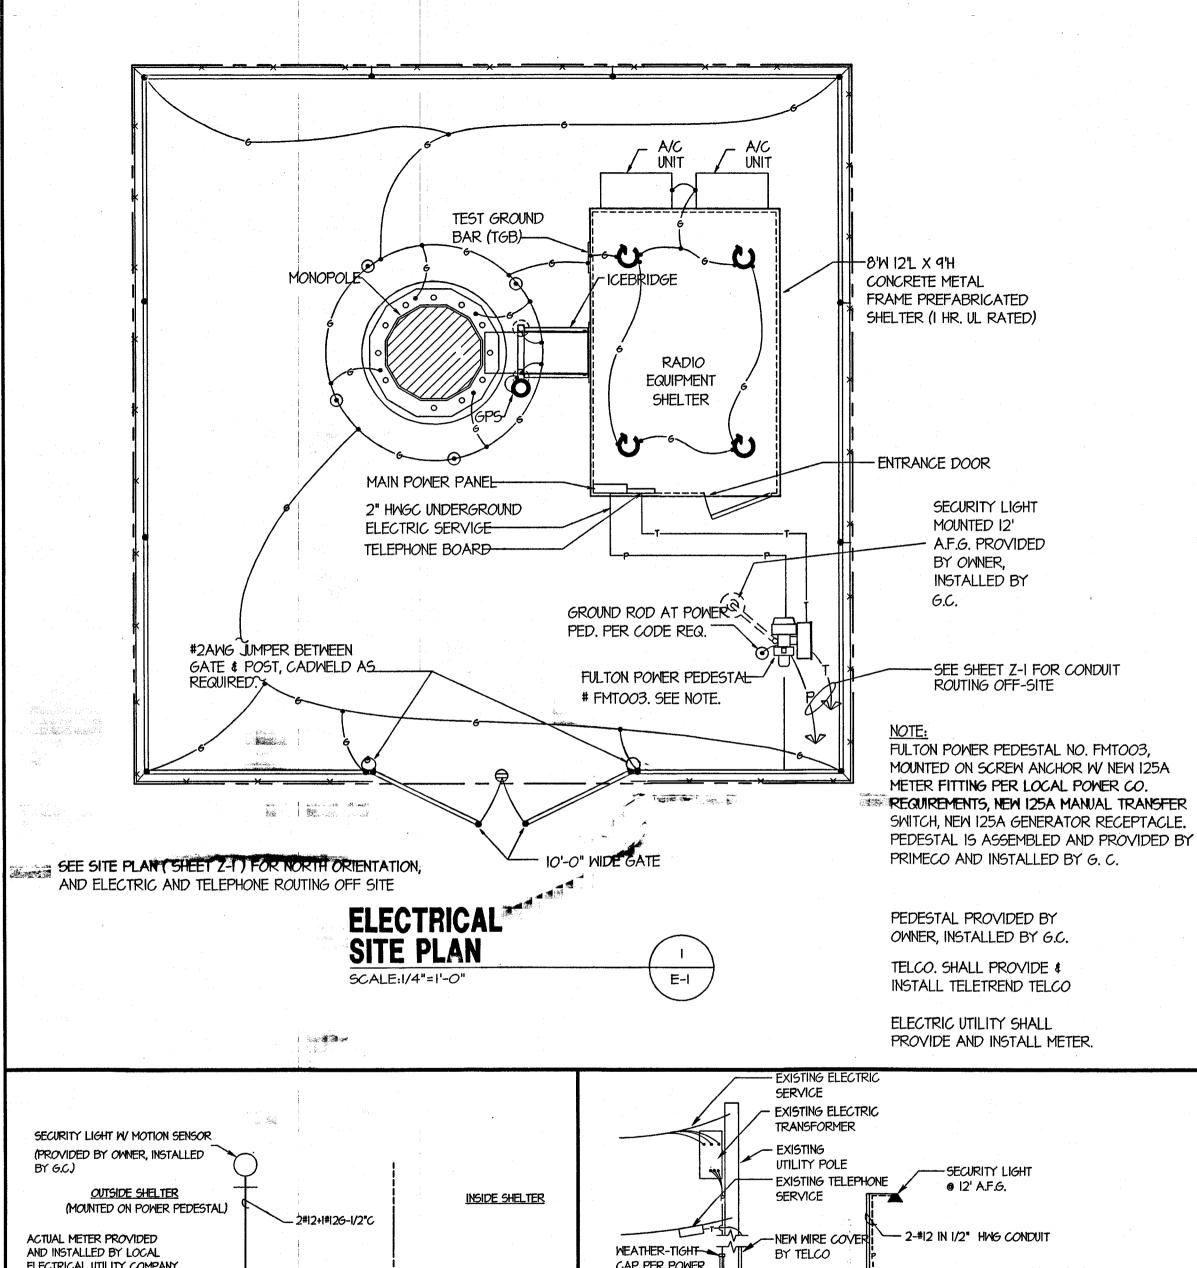

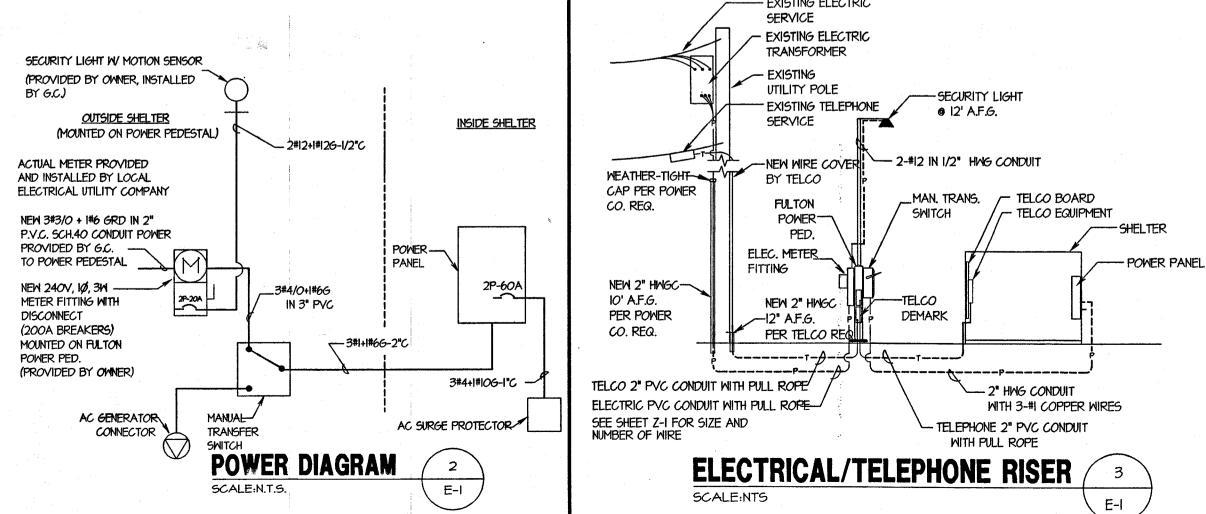

LEGEND

	SAFETY DISCONNECT SWITCH, SIZED AS NOTED	A	AMPERE
	PANELBOARD	V	VOLT
aci min estre di	PANELDOARD	M	MIRE
\bigcirc	KILOWATT HOUR METER	C	CONDUIT
T	TRANSFORMER	6	GROUND
		P	POLE
	CIRCUIT BREAKER	SPGB	SURGE PROTECTOR GROUND BAR
Q	LIGHTING FIXTURE, SIZE AS NOTED		(I/4"x2"x24")
		CGB	COLLECTOR GROUND BAR (1/4"x4"x12
0000	COPPER GROUND BAR, SIZED AS NOTED	EGB	EXTERNAL GROUND BAR (1/4"x8"x24"
. •	EXOTHERMIC WELD CONNECTION	MGB	MASTER GROUND BAR (1/4"x8"x24")
0	COMPRESSION FITTING GROUND CONNECTION		
	COAXIAL CABLE GROUND CONNECTION	IGR	INTERNAL GROUND RING ("HALO" GROUND)
	GROUND TEST PIT	=	
\odot	GROUND ROD	EGR	EXTERNAL GROUND RING
	CROOKE ROD	ACU	AIR CONDITIONER UNIT
—— P——	POWER WIRING, SIZED AS NOTED	A .	THE TON CORTIL ANGLIND
T	TELCO WIRING, SIZED AS NOTED	U	FULTON SCREW ANCHOR
G	GROUND WIRING SIZED AS NOTED		

LANDLORD LEASING ZONING CONSTRUCTION

PRIMECO

ONE PIERCE PLACE SUITE 1100 ITASCA, ILLINOIS 60143 OFFICE: (630) 773-1600 FAX: (630) 285-1580

APPROVALS

PROJECT NO T97170

DRAWN BY CDG

CHECKED BY **KMM**

- THAN, OR THAN INSULATION. SOLID CONDUCTORS FOR #10 AMG AND SMALLER. STRANDED FOR LARGER THAN #10 AWG. MINIMUM SIZE #12 AWG. 5. WIRES AND CABLES FOR POWER AND LIGHTING SHALL BE INSTALLED IN GALVANIZED RIGID STEEL CONDUIT OR FLEXIBLE LIQUIDTIGHT CONDUIT AS INDICATED ON DRAWING.
- 6. CONTRACTOR TO OBTAIN ALL PERMITS, PAY PERMIT FEES, AND BE RESPONSIBLE FOR SCHEDULING INSPECTIONS.

3. ALL ELECTRICAL ITEMS SHALL BE U.L. APPROVED OR LISTED.

ELECTRICAL NOTES

7. CONTRACTOR TO OBTAIN LOCAL POWER AND TELEPHONE COMPANY APPROVAL AND COORDINATE WITH UTILITY COMPANIES SERVICE ENTRANCE REQUIREMENTS.

I. ALL ELECTRICAL WORK SHALL CONFORM TO THE NATIONAL ELECTRICAL CODE

(EDITION ACCEPTED BY LOCAL JURISDICTION) AND APPLICABLE LOCAL CODES.

2. GROUNDING SHALL COMPLY WITH ARTICLE 250 OF THE NATIONAL ELECTRICAL CODE.

4. WIRES AND CABLES FOR POWER AND LIGHTING SHALL BE COPPER WITH TYPE XHHW,

- 8. PROVIDE ALL LABOR AND MATERIAL DESCRIBED ON THIS DRAWING, AND ALL ITEMS INCIDENTAL TO COMPLETING AND PRESENTING THIS PROJECT AS FULLY OPERATIONAL.
- 9. GROUNDING CONNECTIONS SHALL BE EXOTHERMIC TYPE ("CADWELD") TO ANTENNA MASTS, FENCE POSTS, MONOPOLE, AND THE GROUND RODS. REMAINING GROUNDING CONNECTIONS SHALL BE COMPRESSION FITTINGS.
- IO. GROUND COAXIAL CABLE SHIELDS AT BOTH ENDS WITH ANDREWS COAX CABLE GROUNDING KITS
- ROUTE GROUNDING CONDUCTORS ALONG THE SHORTEST AND STRAIGHTEST PATH POSSIBLE, EXCEPT AS OTHERWISE INDICATED. GROUNDING LEADS SHOULD NEVER BE BENT AT RIGHT ANGLE, ALWAYS MAKE AT LEAST 12" RADIUS BENDS. #6 WIRE CAN BE BENT AT 6" RADIUS WHEN NECESSARY.
- 12. CONTRACTOR TO PROVIDE GROUND RODS AND GROUND RING AS SHOWN ON ELECTRICAL SITE PLAN AND GROUNDING RISER DIAGRAM. CONTRACTOR SHALL TEST AND VERIFY THAT THE IMPEDANCE DOES NOT EXCEED 5 OHMS TO GROUND BY MEANS OF A BIDDLE-MEGGER TESTER, GROUNDING AND OTHER OPERATIONAL TESTING SHALL SHALL BE WITNESSED BY THE OWNER'S REPRESENTATIVE.
- 13. CONTRACTOR TO PROVIDE 2" SCHEDULE 40 PVC UNDERGROUND CONDUIT WITH PULL WIRE BETWEEN TELEPHONE COMPANY DEMARCATION POINT AND TELCO LINE BOX ON POWER PEDESTAL. CONTRACTOR SHALL PROVIDE 2" HMGC FROM POWER PEDESTAL TO SHELTER WITH PENETRATION FITTING.
- 14. CONTRACTOR TO PROVIDE 2" O SCHEDULE 40 PVC UNDERGROUND CONDUIT WITH PULL WIRE BETWEEN ELECTRICAL UTILITY COMPANY DEMARCATION POINT AND KWH METER BASE ON POWER PEDESTAL. CONTRACTOR SHALL PROVIDE 2" HWGC FROM POWER PEDESTAL TO SHELTER WITH PENETRATION FITTING.
- 15. NOTIFY JULIE. (1-800-892-0123) PRIOR TO ANY EXCAVATION.
- 16. CONTRACTOR TO PROVIDE GROUND INSPECTION WELL, REFER TO APPROPRIATE DETAIL ON DRAWING E-3.
- 17. GROUNDING CONDUCTORS SHALL BE COPPER ONLY. ABOVE GROUND EITHER SOLID OR STRANDED CONDUCTORS ARE PERMITTED. IGR AND ALL EXTERNAL CONDUCTORS (WITH THE EXCEPTION FOR GROUND WIRE BETWEEN THE TOP AND THE BOTTOM OF THE ANTENNA TOWER) MUST BE BARE. EQUIPMENT GROUND LEADS IN CABLE TRAYS MUST BE GREEN INSULATED. BELOW GROUND BARE SOLID TINNED WIRE SHALL BE USED. ALL WIRES MUST BE #2 AWG MIN. WITH THE EXCEPTION OF GROUND WIRES FOR MISCELLANEOUS METALLIC OBJECTS IN THE EQUIPMENT SHELTER, WHERE #6 AWG WIRES CAN BE USED.
- 18. THE GROUND ELECTRODE SYSTEM SHALL CONSIST OF DRIVEN GROUND RODS UNIFORMLY SPACED AROUND CELL SITE. THE GROUND RODS SHALL BE 5/8"x8'-O" COPPER CLAD STEEL. THE RODS SHALL BE INTERCONNECTED WITH #2 AWG BARE SOLID TINNED COPPER GROUND WIRE BURIED 30" BELOW THE SURFACE OF THE SOIL, MINIMUM DISTANCE BETWEEN GROUND RODS - 8', MAXIMUM - 16'



FOR CONSTRUCTION

6-24-97


W-T ENGINEERING, INC. CONSULTING ENGINEER 39 EAST SCULLY DRIVE SCHAUMBURG, ILLINOIS 60193 ph. (847) 895-3640 fax. (847) 895-9985

CGB 3614-7 SOUTH/CENTRAL DECATUR

CLARKSON GRAIN COMPANY SOUTH BROADWAY DECATUR, IL

ELECTRICAL PLAN. RISER, NOTES AND DETAILS

E-1

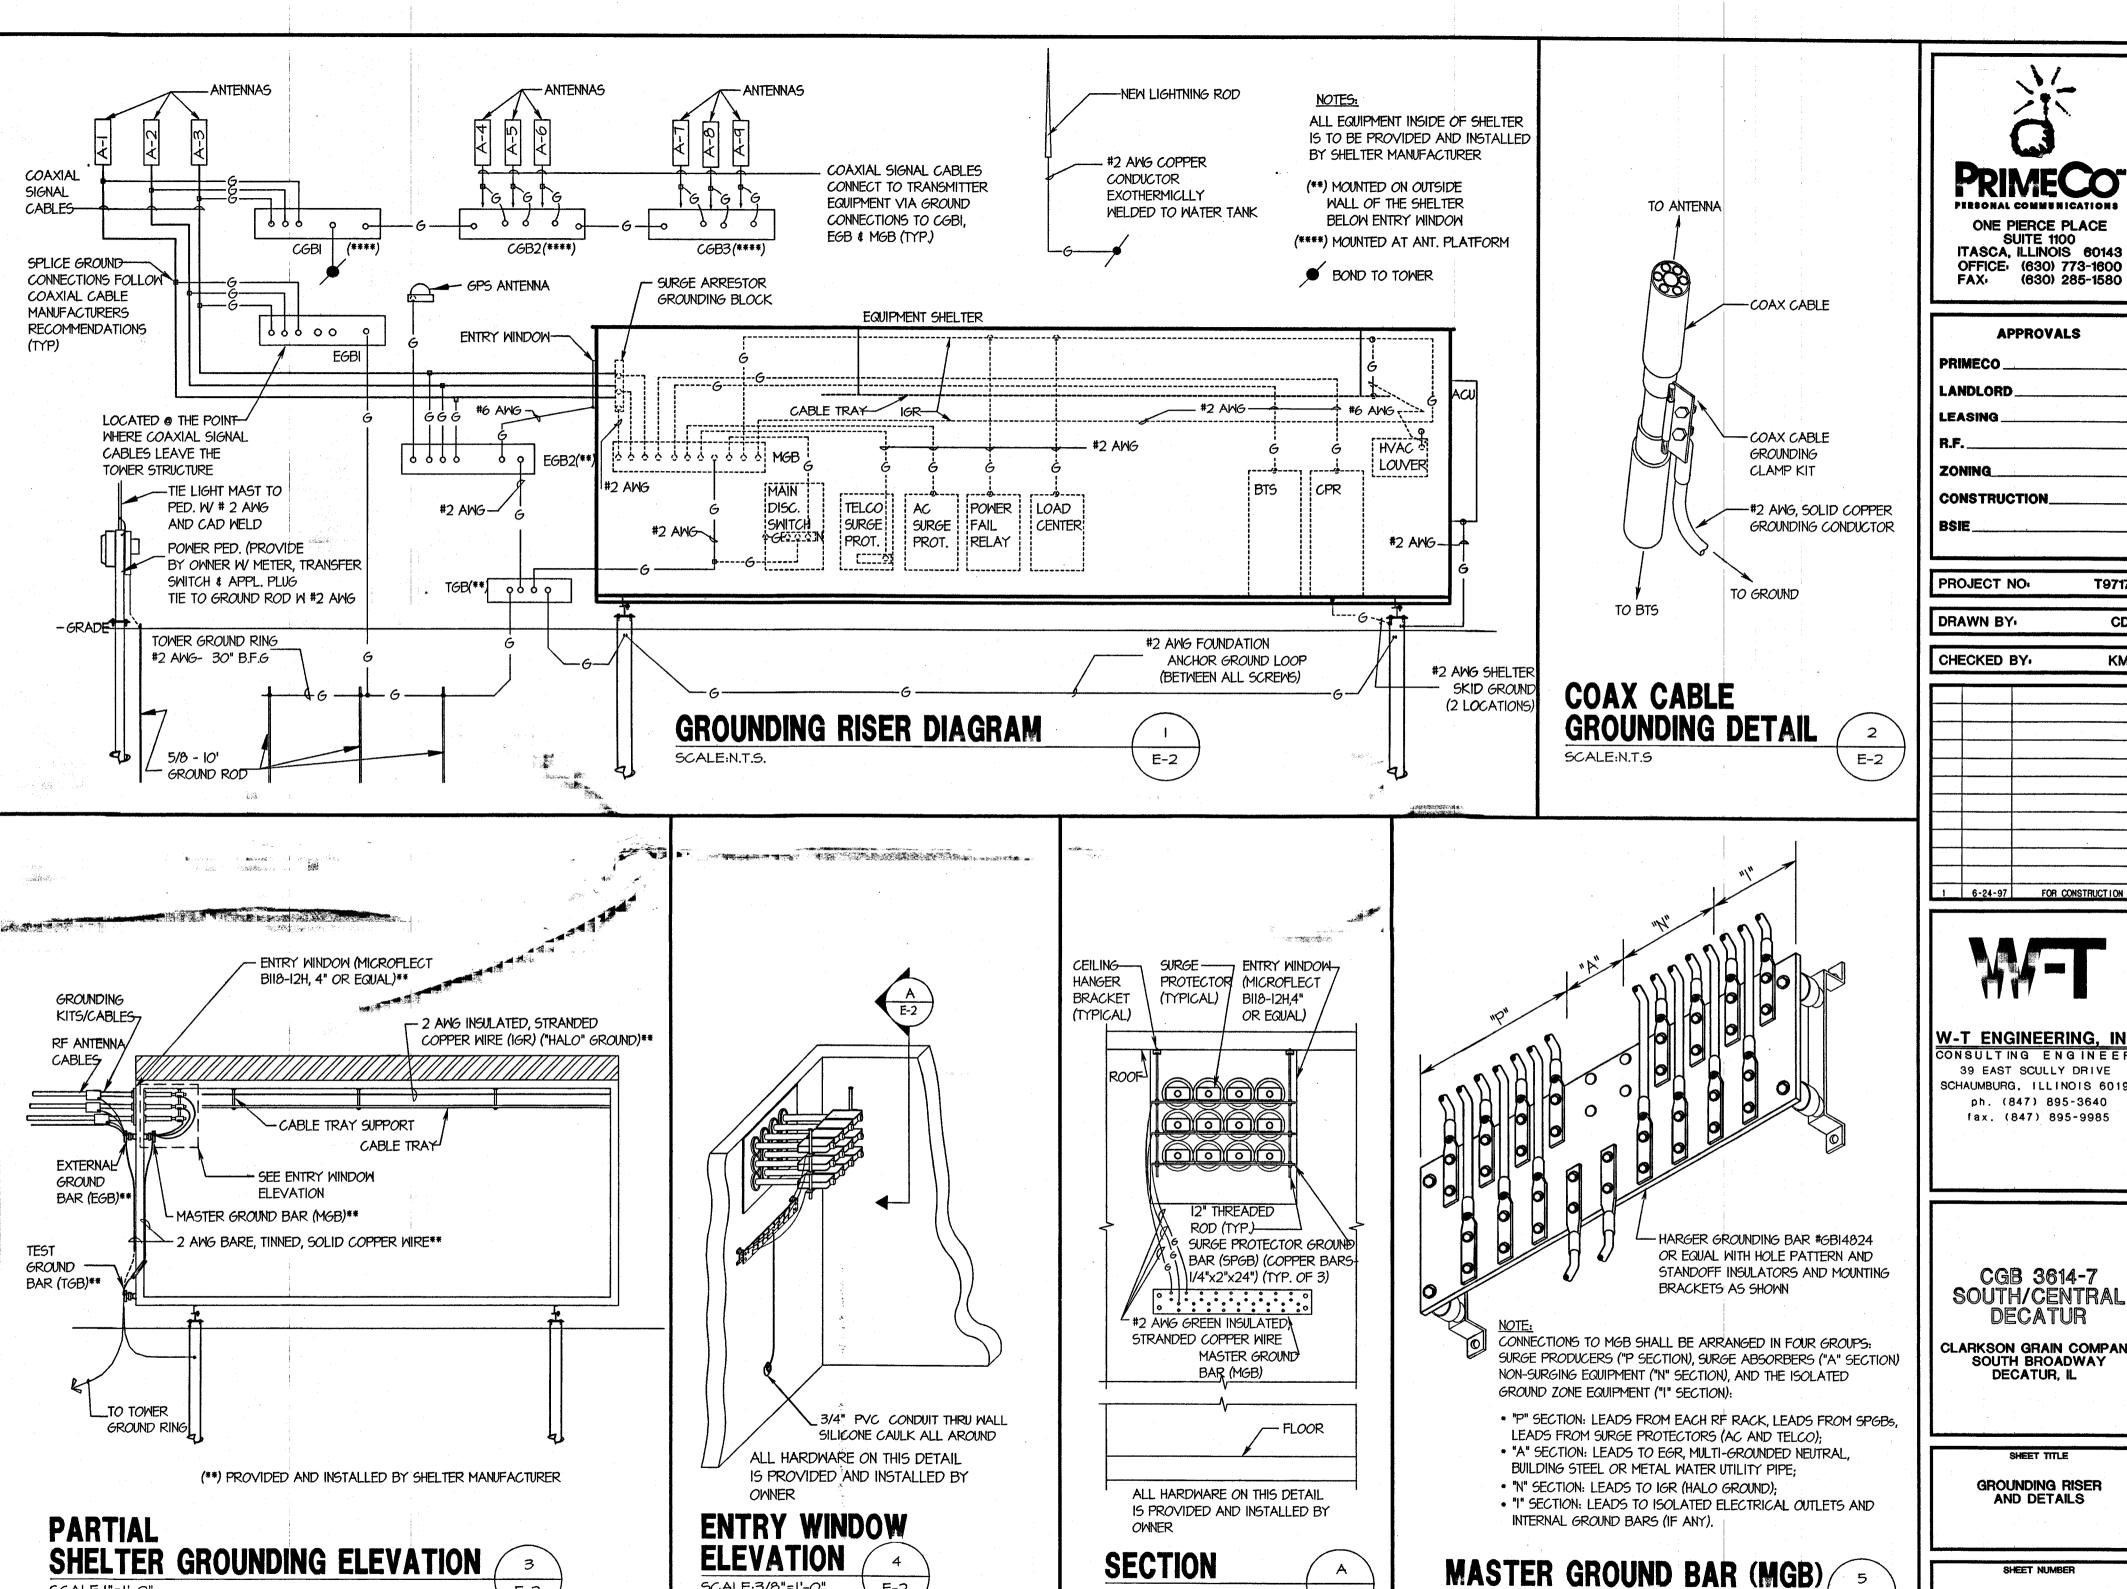

SCALE:3/8"=1'-0"

E-2

SCALE:3/4"=1'-0"

E-2

SCALE: N.T.S.

ONE PIERCE PLACE

APPROVALS CONSTRUCTION

T97170

CDG

CHECKED BY **KMM**



W-T ENGINEERING, INC

CONSULTING ENGINEERS 39 EAST SCULLY DRIVE SCHAUMBURG, ILLINOIS 60193 ph. (847) 895-3640 fax. (847) 895-9985


CGB 3614-7 SOUTH/CENTRAL DECATUR

CLARKSON GRAIN COMPANY SOUTH BROADWAY DECATUR, IL


GROUNDING RISER AND DETAILS

E-2

E-2

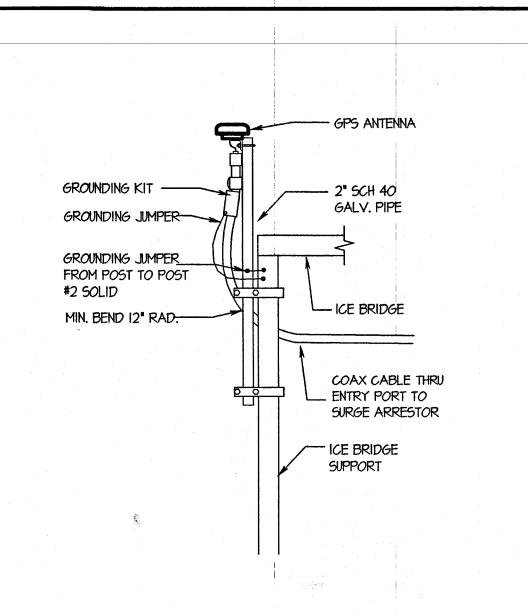



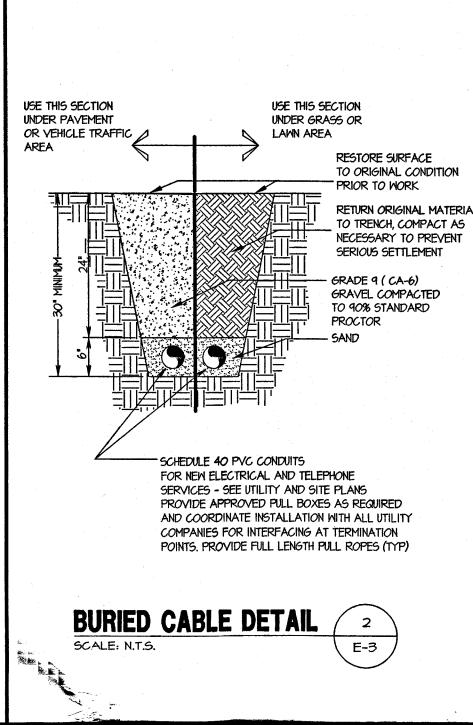


	(A	ITENNA ANI	D COA	XIAL	CABL	E SC	HEDUL	E
ANTENNA MARK	SECTOR	ANTENNA	COAXIAL CABLE FEED LOCATION	DOWN-TILT	AZIMUTH	ANTENNA & HEIGHT	COAXIAL CABLE MARK	COAXIAL CABLE
A-I	l	ALLEN TELECOM DB980H90E (63"x 6.3"x 2")	воттом	SEE NOTE I.	SEE NOTE 3.	SEE NOTE 2.	C-1	SEE NOTE 4.
A-2	I	-FUTURE-						
A-3	ı	ALLEN TELECOM DB980H90E (63"x 6.3"x 2")	воттом	SEE NOTE I.	SEE NOTE 3.	SEE NOTE 2.	cl3	SEE NOTE 4.
A-4	2	ALLEN TELECOM DB980H90E (63"x 6.3"x 2")	Воттом	SEE NOTE I.	SEE NOTE 3.	SEE NOTE 2.	C ^L 4	SEE NOTE 4.
A-5	2	-FUTURE-			 .			
A-6	2	ALLEN TELECOM DB980H90E (63"x 6.3"x 2")	ВОТТОМ	SEE NOTE I.	SEE NOTE 3.	SEE NOTE 2.	C-6	SEE NOTE 4.
A-7	3	ALLEN TELECOM DB980H90E (63"x 6.3"x 2")	воттом	SEE NOTE I.	SEE NOTE 3.	SEE NOTE 2.	C-7	SEE NOTE 4.
A-8	3	-FUTURE-						<u></u>
A-9	3	ALLEN TELECOM DB980H90E (63"x 6.3"x 2")	воттом	SEE NOTE I.	SEE NOTE 3.	SEE NOTE 2.	c ^l q	SEE NOTE 4.

COAX CABLE CHART								
COAX CABLE LENGTH	CABLE TYPE AND DIAMETER							
I. LESS THAN 65'	HELIAX 7/8*¢ LDF5-50A							
2. 65' TO 130'	HELIAX I I/4"¢ LDF6-50							
3. I30' TO 225'	HELIAX Ι 5/8"Φ LDF7-50A							
4. MORE THAN 225'	HELIAX 2 I/4"Φ LDFI2-50							

NOTES


- I. ALL ANTENNAS TO BE FURNISHED WITH DOWNTILT BRACKETS. CONTRACTOR TO COORDINATE REQUIRED MECHANICAL DOWNTILT FOR EACH ANTENNA WITH RF ENGINEER.
- 2. ANTENNA CENTERLINE HEIGHT IS IN REFERENCE TO ELEVATION O.O'. ANTENNA HEIGHTS ARE SHOWN ON TOWER ELEVATION SHEET Z-2
- 3. ANTENNA AZIMUTHS SHOWN ON SITE PLAN. SHEET Z-I
- 4. SEE COAX CABLE CHART AT LEFT FOR CABLE DIAMETERS.
- 5. CHECK WITH RF ENGINEER FOR LATEST ANTENNA TYPE & AZIMUTH.
- 6. CONTRACTOR SHALL VERIFY ANTENNA TYPE AND AZIMUTH WITH CONSTRUCTION MANAGER PRIOR TO CONSTRUCTION.

E-3

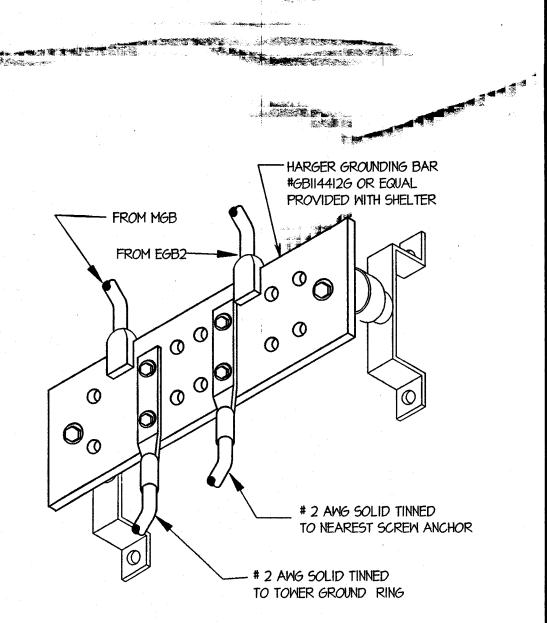


TEST GROUND BAR (TGB)


SCALE: N.T.S.

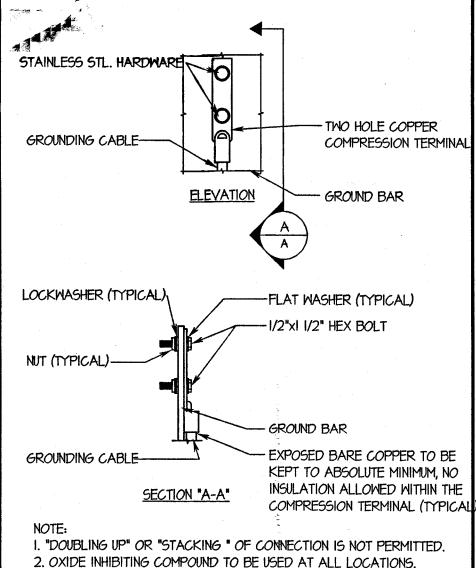

TYPICAL GROUND BAR **CONNECTIONS DETAIL** SCALE: N.T.S.

E-3

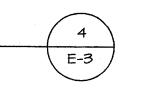

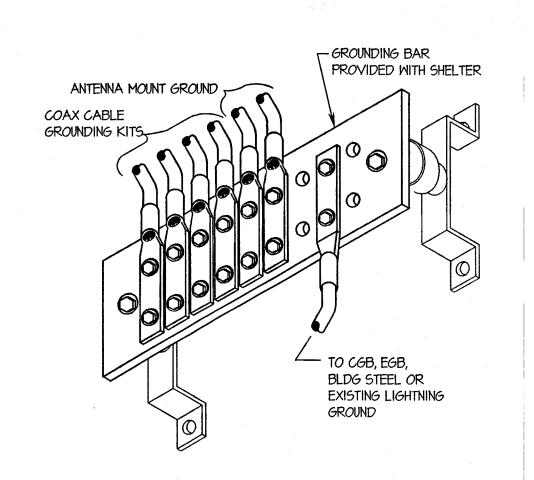

COLLECTOR GROUND BAR (CGB) SCALE: N.T.S.

ONE PIERCE PLACE

SUITE 1100

ITASCA, ILLINOIS 60143 OFFICE: (630) 773-1600

FAX: (630) 285-1580 **APPROVALS** PRIMECO. LANDLORD LEASING R.F.

ZONING CONSTRUCTION

PROJECT NO. T97170

CDG

DRAWN BY-

CHECKED BY.

KMM 1 6-24-97 FOR CONSTRUCTION



W-T ENGINEERING, INC. CONSULTING ENGINEERS

39 EAST SCULLY DRIVE SCHAUMBURG, ILLINOIS 60193 ph. (847) 895-3640 fax. (847) 895-9985

CGB 3614-7 SOUTH/CENTRAL DECATUR

CLARKSON GRAIN COMPANY SOUTH BROADWAY DECATUR, IL

ELEVATIONS, AND ANTENNA SCHEDULE

SHEET NUMBER

E-3