ABBREVIATIONS

		ABBREV
1	ADJ APPROX CAB CLG	ADJUSTABLE (APPROXIMATE CABINET CEILING
	CONC	CONCRETE
	CJ DIA DWG	CONSTRUCTION JOINT DIAMETER DRAWING
	EGB EA ELEC	EQUIPMENT GROUND BAR EACH ELECTRICAL
	EL EQ EQUIP	ELEVATION EQUAL EQUIPMENT
	EXT FF GA	EXTERIOR FINISHED FLOOR GAUGE
	GALV GC GRND	
	LG MAX	LONG MAXIMUM

MECHANICAL

MINIMUM **METAL**

OPPOSITE

MANUFACTURER

NOT IN CONTRACT NOT TO SCALE ON CENTER

MASTER GROUND BAR

MECH


SQUARE FOOT SHT SHEET SIMILAR STAINLESS STEEL STEEL TOP OF CONCRETE TOP OF MASONRY VERIFY IN FIELD UNLESS OTHERWISE NOTED WELDED WIRE FABRIC BASE TRANSMISSION STATION PERSONAL

COMMUNICATIONS SERVICES ANTENNA MARK NO. CENTERLINE

PLATE

AND

AT:

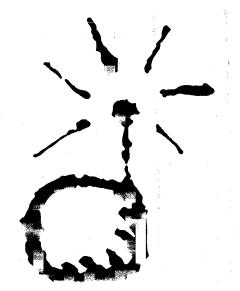

PRMECO

PERSONAL COMMUNICATIONS

DECATUR N.E.

2205 BRUSH COLLEGE ROAD **DECATUR, ILLINOIS 62526**

CGB 3617-2

PROPOSED COMMUNICATION SITE WITH 150' MONOPOLE AND 8'x12' EQUIPMENT SHELTER

NORTH

VICINITY MAP

SITE NAME: DECATUR N.E. SITE ADDRESS: 2205 BRUSH COLLEGE ROAD, DECATUR, ILLINOIS 62526 PROPERTY OWNER: FS SERVICES LOT NUMBER: 6 BLOCK NUMBER: NA APPLICANT: PRIMECO PERSONAL COMMUNICATIONS, L.P. ONE PIERCE PLACE, SUITE 1100 ITASCA, ILLINOIS 60143 CONTACT PERSON: JOE PECKENS CONTACT PHONE NO.: (630) 773-1600 ASSESSOR'S PARCEL NO.: 13-06-477-01

PROJECT SUMMARY

SITE NUMBER: CGB 3617-2 NO SCALE

DRIVING DIRECTIONS

FROM PRIMECO OFFICES IN ITASCA:

FROM CHICAGO TAKE 55 SOUTH TO BLOOMINGTON AND EXIT 51 SOUTH INTO DECATUR. AT NORTH SIDE OF DECATUR EXIT OFF 51 SOUTH ONTO 12 GOING EAST. THEN EXIT HIGHWAY 48 (22 ND STREET) GOING SOUTH. TAKE FIRST LEFT ONTO BRUSH COLLEGE ROAD CONTINUING SOUTH, FOLLOW BRUSH COLLEGE ROAD 2.5 MILES TO FS SEEDS WAREHOUSE ON RIGHT. SITE IS AT REAR OF

CONTRACTOR SHALL VERIFY ALL PLANS AND EXISTING DIMENSIONS AND CONDITIONS ON THE JOB SITE AND SHALL IMMEDIATELY NOTIFY THE ARCHITECT IN WRITING OF ANY DISCREPANCIES BEFORE PROCEEDING WITH THE WORK OR BE RESPONSIBLE FOR SAME

Manager -	SHT. NO.	DESCRIPTION	REV. NO.
	T-I	TITLE SHEET	
	LS-I	SITE SURVEY	
	Z-I	SITE PLAN	
	Z-2	ELEVATIONS	
	A-I	SITE PLAN, AND PROJECT NOTES	
•	A-2	ANTENNA LOCATION PLAN, SECTIONS	
		AND ELEVATIONS	
	A-3	SECTIONS	
	5-1	SCREW ANCHOR FOUNDATION SECTIONS,	
		AND DETAILS	
	E-I	ELECTRICAL PLAN, RISER, NOTES, DETAILS	
	E-2	GROUNDING RISER AND DETAILS	
	E-3	ELEVATIONS, AND ANTENNA SCHEDULE	
	SHI	EET INDEX	

PROFESSIONAL ENGINEER

ING. INC.	W-T ENGINE	
		١

LICENSED PROFESSIONAL ENGINEER - STATE OF ILLINOIS

SCOTT R. TRIPHAHN EXPIRES: 11/30/97 SIGNED: / ONE PIERCE PLACE

SUITE 1100 ITASCA, ILLINOIS 60143

OFFICE: (630) 773-1600 FAX: (630) 285-1580

APPROVALS PRIMECO. LANDLORD. ZONING CONSTRUCTION FIXNET

PROJECT NO T97176 DRAWN BY CDG

CHECKED BY **KMM**

	 	
	ļ	
	<u> </u>	
4	08-12-97	REVISED FENCE HT.
3	08-11-97	ADDED LANDSCAPING
2	07-14-97	FOR CONSTRUCTION
1	07-10-97	FOR ZONING



W-T ENGINEERING, INC 39 EAST SCULLY DRIVE SCHAUMBURG, ILLINOIS 60193 ph. (847) 895-3640 fax. (847) 895-9985


> CGB 3617-2 DECATUR N.E.

2205 BRUSH COLLAGE RD. DECATUR, ILLINOIS


TITLE SHEET

T-1

EXHIBITA

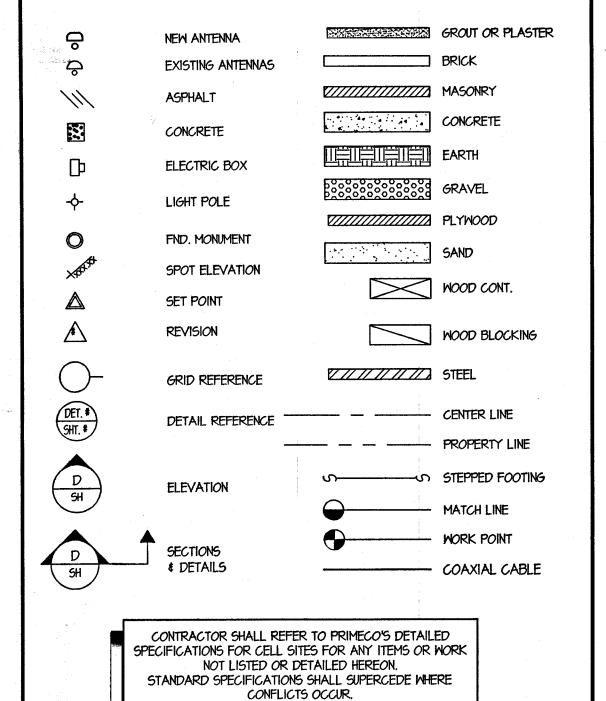

SYMBOLS AND MATERIALS

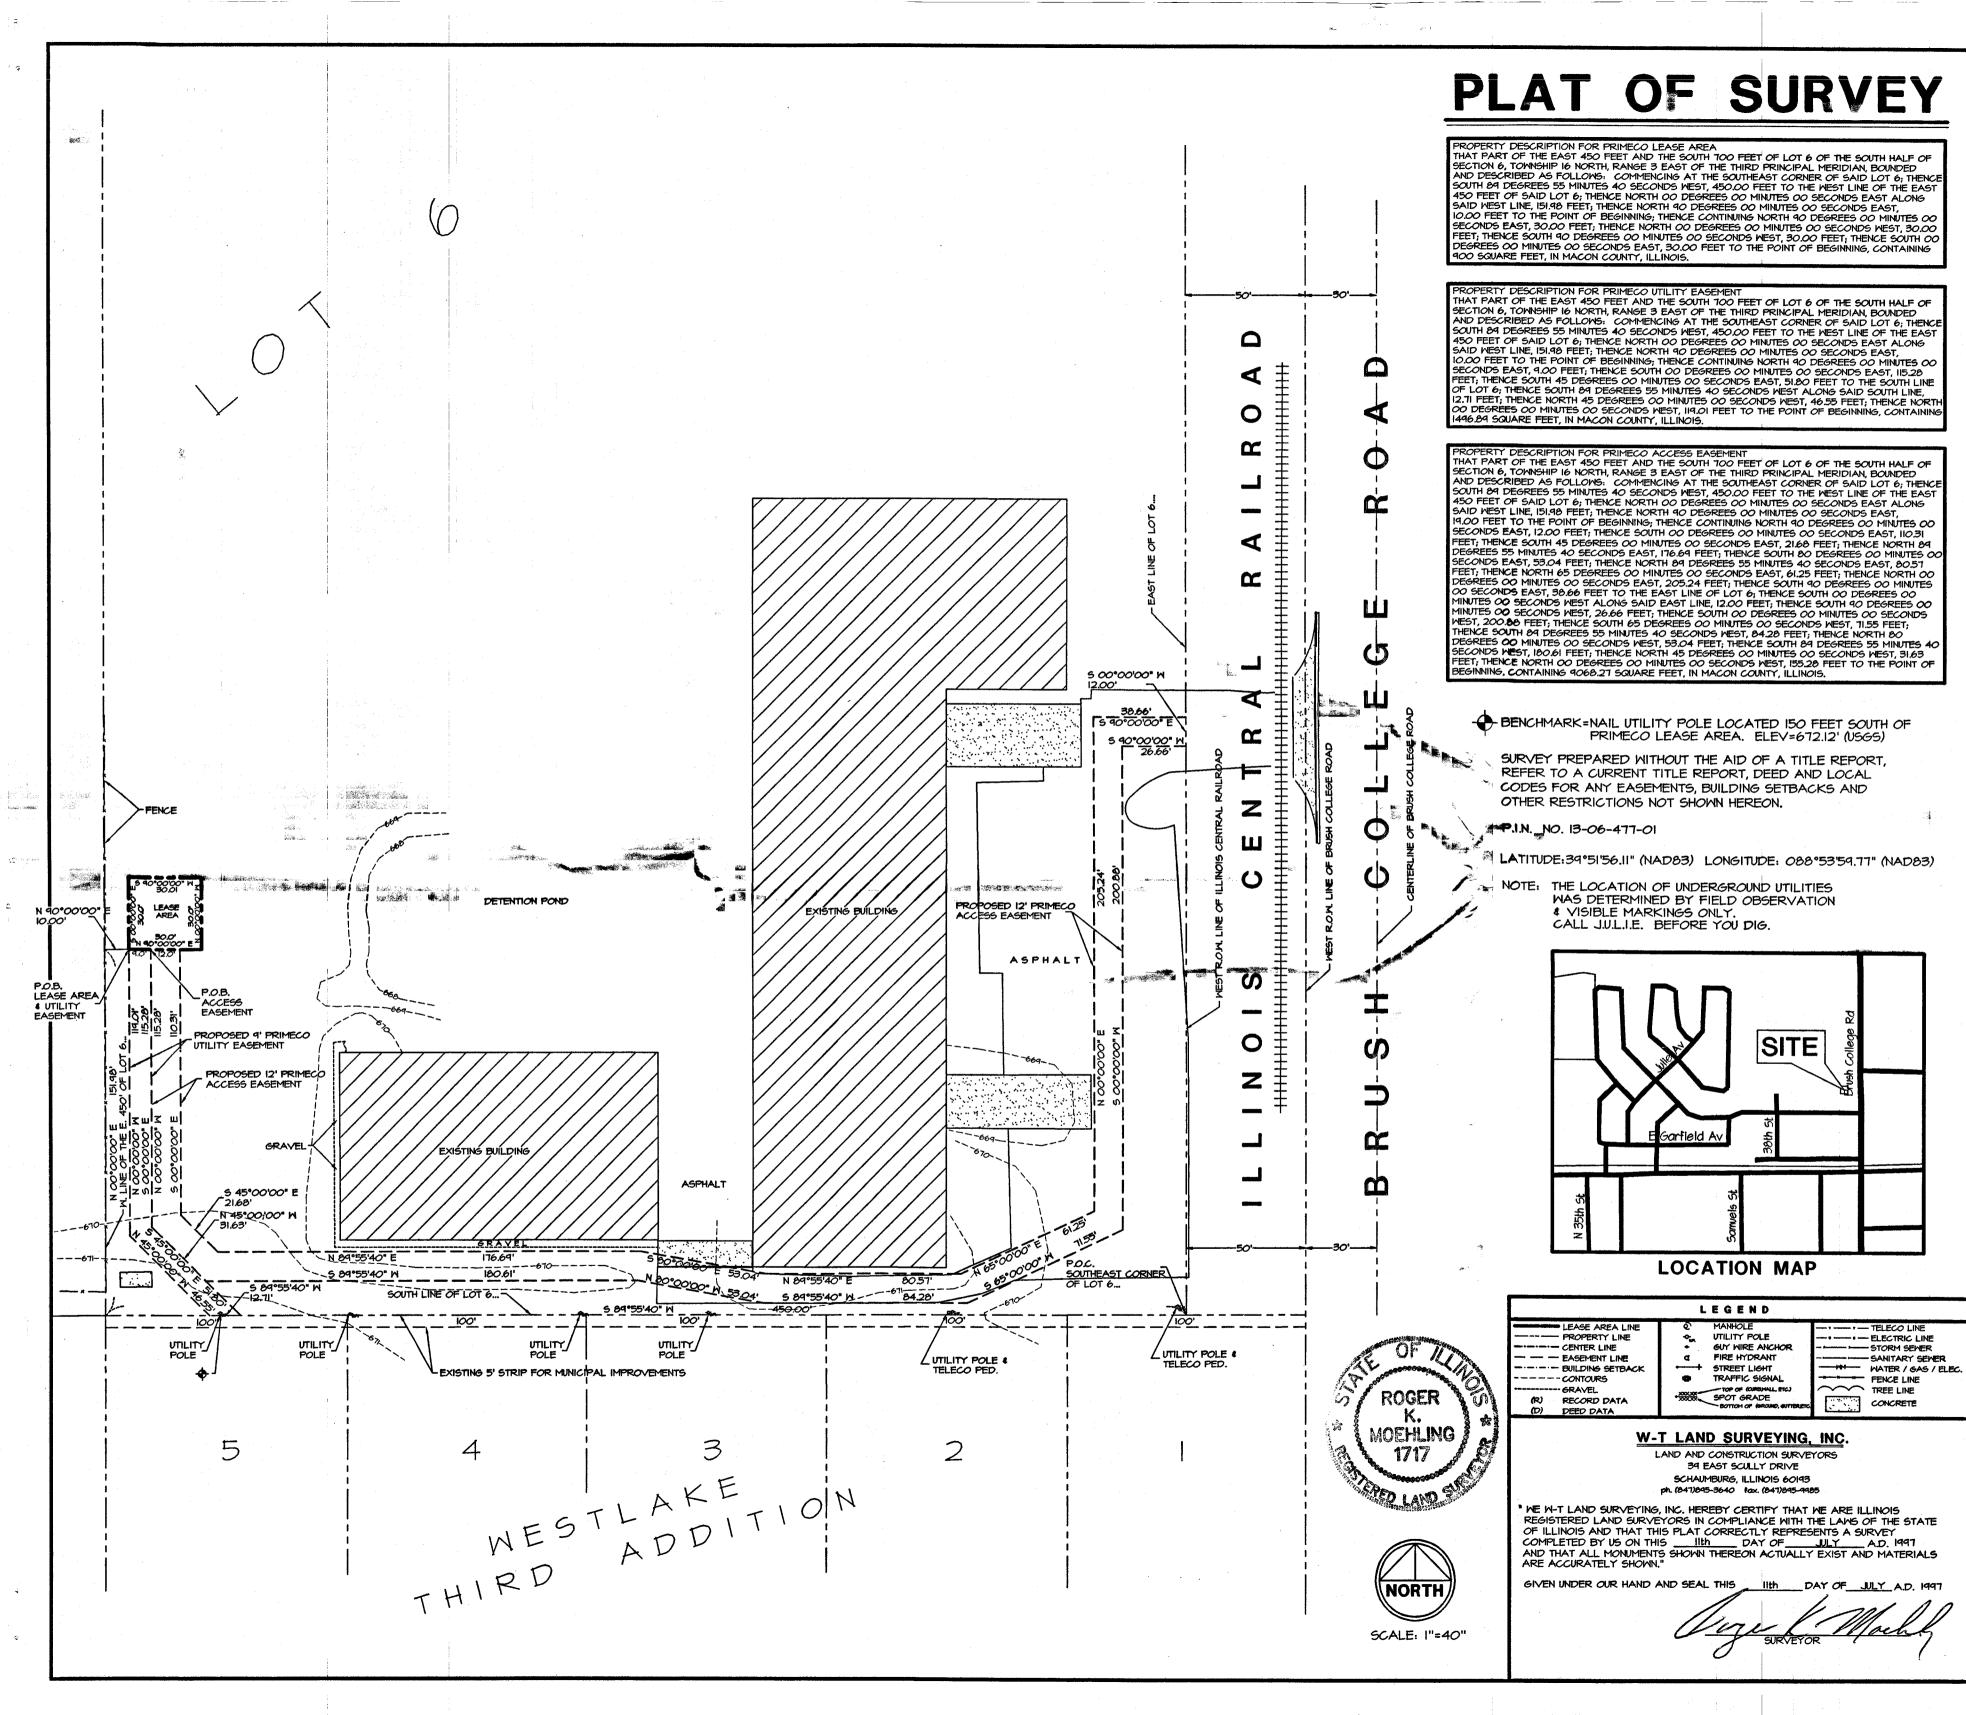



ONE PIERCE PLACE SUITE 1100 ITASCA, ILLINOIS 60143 OFFICE: (630) 773-1600 FAX: (630) 285-1580

	APPROVALS
P	RIMECO
L	ANDLORD
L	EASING
R	i.F
z	ONING
C	ONSTRUCTION
В	SIE

DRAWN BY

PROJECT NO

CHECKED BY: KMM

T97176

CDG

CHECKED B11 KIMIM

W-T LAND SURVEYING, INC.
LAND AND CONSTRUCTION SURVEYORS

39 EAST SCULLY DRIVE SCHAUMBURG, ILLINOIS 60193 ph. (847) 895-3640 fax. (847) 895-9985

> CGB 3617-2 NORTHEAST DECATUR


2205 BRUSH COLLEGE ROAD DECATUR ILLINOIS

SHEET TITLE

LAND SURVEY

SHEET NUMBER

LS-1

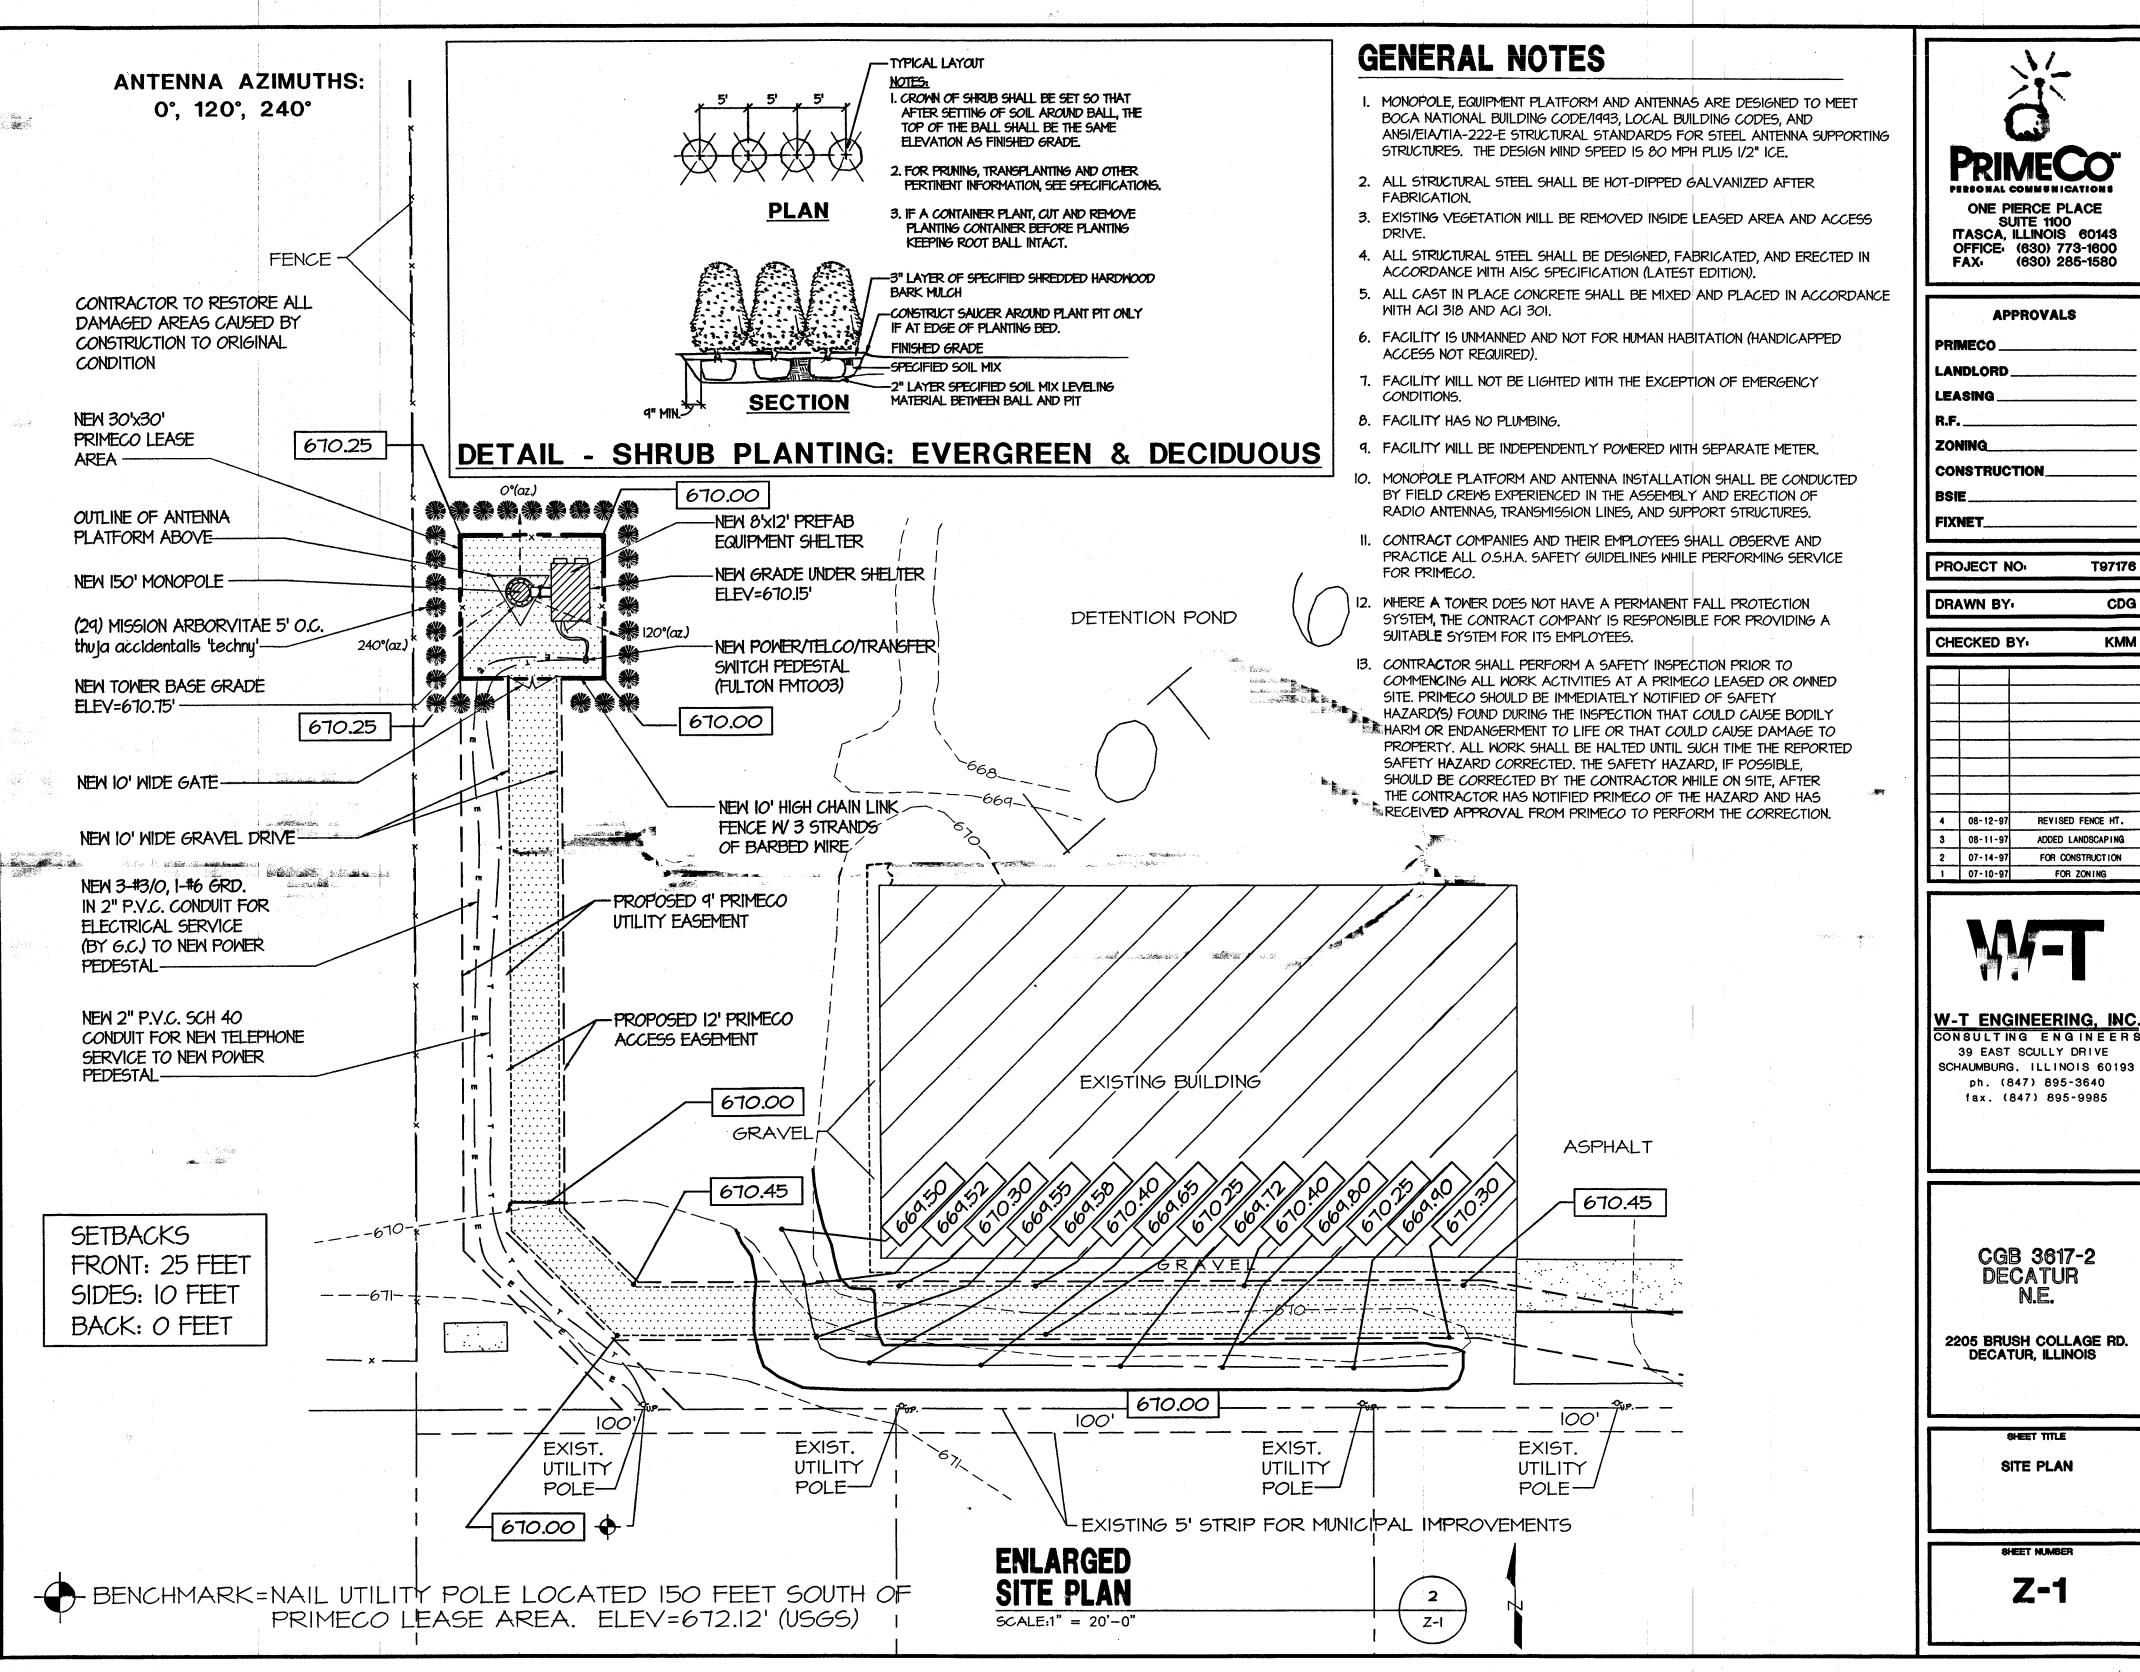



ONE PIERCE PLACE SUITE 1100 ITASCA, ILLINOIS 60143 OFFICE: (630) 773-1600 (630) 285-1580

APPRO	VALS	
PRIMECO		
LANDLORD		
LEASING		
R.F	·:	
ZONING		
CONSTRUCTION	N	
BSIE		
FIXNET		

	DR/	WN BY	CDG
	CHE	ECKED B	/ı KMM
ŀ	·		
\mathbf{l}			name and the second
ŀ			
t			
Г	4	08-12-97	REVISED FENCE HT.

T97176




39 EAST SCULLY DRIVE

SCHAUMBURG, ILLINOIS 60193 ph. (847) 895-3640 fax. (847) 895-9985

> CGB 3617-2 DECATUR

BHEET NUMBER

Z-1

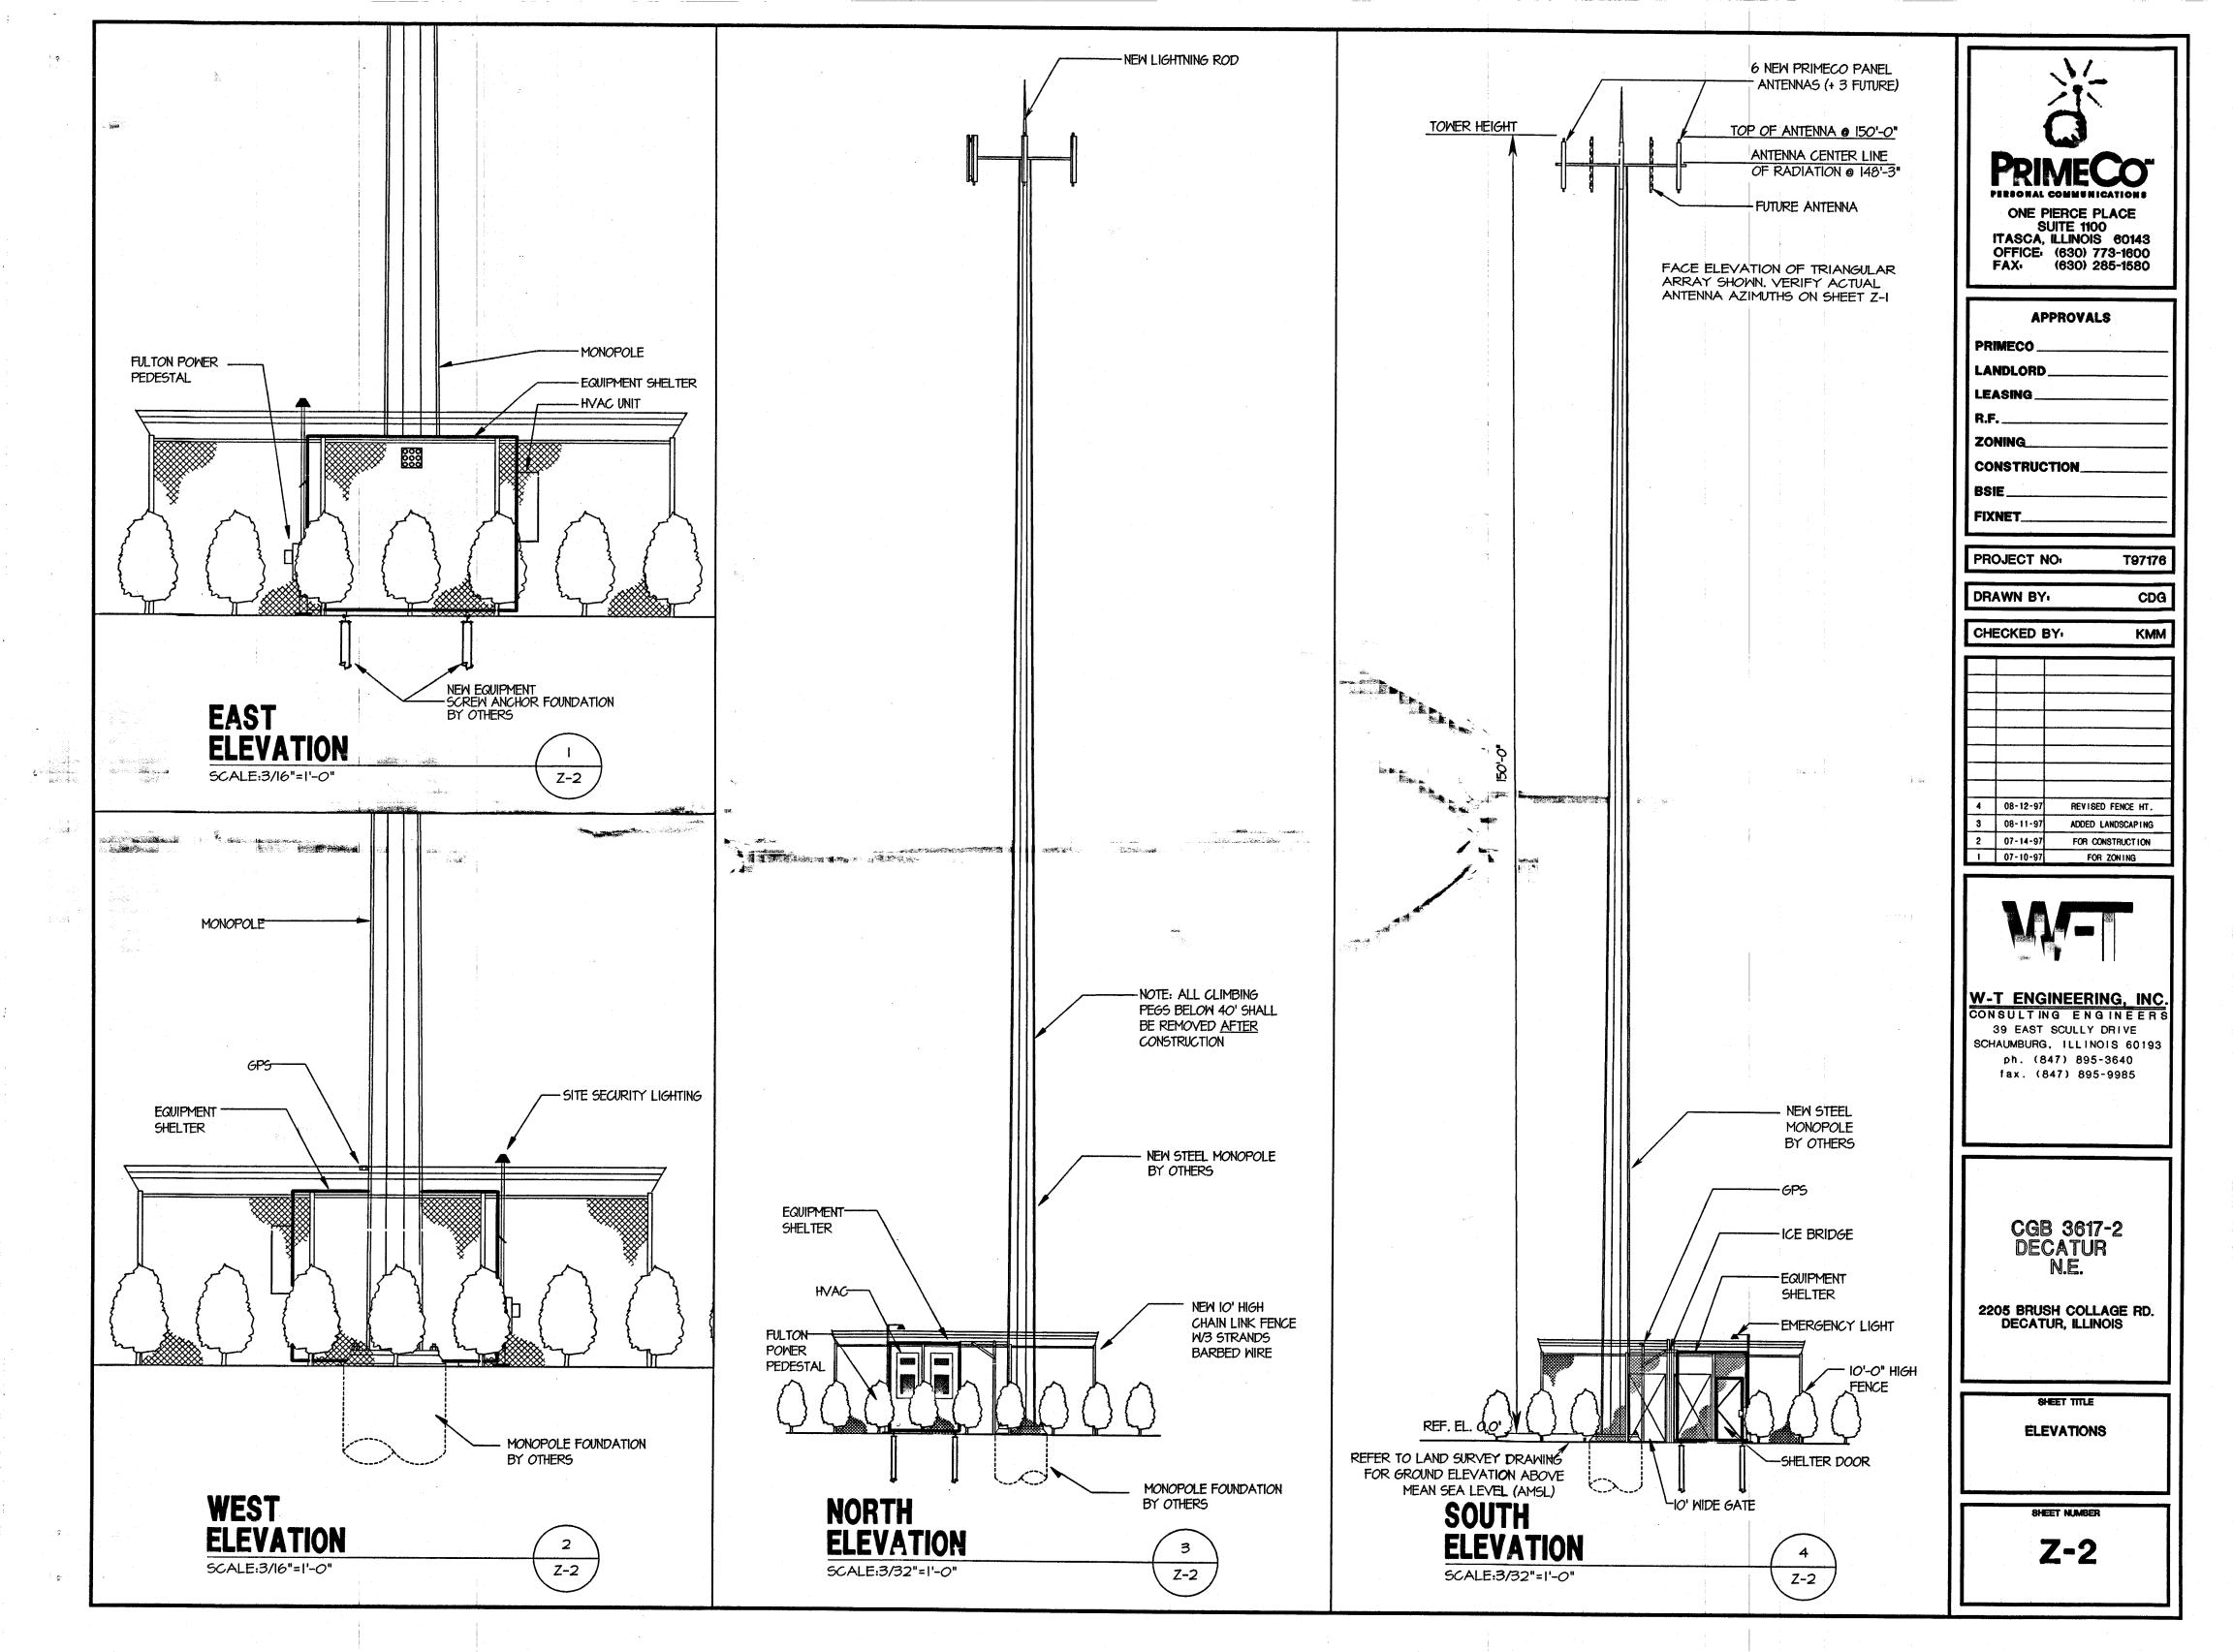


PROJECT NOTES

- THE GENERAL CONTRACTOR AND OR HIS SUBCONSULTANT SHALL BE RESPONSIBLE FOR OBTAINING ALL PERMITS AND INSPECTIONS WHICH MAY BE REQUIRED FOR THE WORK BY THE ARCHITECT/ENGINEER, THE STATE, COUNTY OR LOCAL GOVERNMENT AUTHORITY.
- 2. REFER TO THE SITE PLAN PREPARED BY OTHERS FOR BOUNDARY SURVEY AND SITE TOPOGRAPHY.
- 3. DESIGN REQUIREMENTS FOR THE ANTENNA SUPPORTING STRUCTURE ARE PER BOCA NATIONAL BUILDING CODE/1993, LOCAL BUILDING CODES, AND THE EIA/ TIA-222-E STRUCTURAL STANDARDS FOR STEEL ANTENNA SUPPORTING STRUCTURES. THE BASIC WIND SPEED UTILIZED FOR DESIGN IS 80 MPH PLUS 1/2" ICE.
- 4. CONCRETE FOR FENCE POST AND ICEBRIDGE SUPPORT SHALL BE 3000 PSI AIR ENTRAINED (4%-6%) NORMAL WEIGHT CONCRETE.
- 5. FENCED SITE AREA SHALL BE CLEARED AND GRUBBED. REMOVE UNSUITABLE SOFT OR LOOSE SOILS, ORGANIC MATERIAL AND OR RUBBLE TO FIRM SUBGRADE AS APPROVED BY GEOTECHNICAL REPORT. PLACE A MIRAFI 500X SHEET ON SUBGRADE AND FILL WITH 4 INCHES OF AASHTO 57 STONE TO FINISH GRADE.
- 6. STRUCTURAL STEEL SHALL CONFORM TO LATEST EDITION OF THE AISC SPECIFICATION FOR STRUCTURAL STEEL BUILDINGS- ALLOWABLE STRESS DESIGN AND PLASTIC DESIGN INCLUDING THE COMMENTARY AND THE CODE OF STANDARD PRACTICE.
- 7. STRUCTURAL STEEL PLATES AND SHAPES SHALL CONFORM TO ASTM A36.
 ALL STRUCTURAL STEEL PIPES SHALL CONFORM TO ASTM A53 GRADE B.
 ALL STRUCTURAL STEEL COMPONENTS AND FABRICATED ASSEMBLIES SHALL BE HOT DIP GALVANIZED AFTER FABRICATION.
- 8. WELDING SHALL BE IN ACCORDANCE WITH THE AMERICAN WELDING SOCIETY (AWS) D.I.I-92 STRUCTURAL WELDING CODE- STEEL WELD ELECTRONICS SHALL BE ETOXX.
- 9. ALL THREADED STRUCTURAL FASTENERS FOR ANTENNA SUPPORT ASSEMBLIES SHALL CONFORM TO ASTM A325. FASTENERS SHALL BE 5/8" MINIMUM DIAMETER BEARING TYPE CONNECTIONS WITH THREADS INCLUDED IN THE SHEAR PLANE. ALL EXPOSED FASTENERS, NUTS AND WASHERS SHALL BE GALVANIZED UNLESS OTHERWISE NOTED. CONCRETE EXPANSION ANCHORS SHALL BE HILTI KWIK BOLTS UNLESS OTHERWISE NOTED.
- IO. ALL COAXIAL CABLE CONNECTORS AND TRANSMITTER EQUIPMENT SHALL BE AS SPECIFIED BY THE OWNER. THE CONTRACTOR SHALL FURNISH ALL CONNECTION HARDWARE REQUIRED TO SECURE THE CABLES.
- II. STEEL FENCE SYSTEM SHALL INCLUDE THE FENCE POSTS, FABRIC, GATE SYSTEM AND ALL NECESSARY ERECTION ACCESSORIES, FITTINGS, AND FASTENINGS. ALL FENCE SYSTEM COMPONENTS SHALL BE GALVANIZED IN ACCORDANCE WITH ASTM AIS3. GATES SHALL BE SWING GATES WITH 4'-O" LEAFS. REFER TO TYPICAL FENCE DETAILS AND SPECIFICATIONS FOR ADDITIONAL INFORMATION. INSTALL FENCE AFTER CONCRETE HAS ATTAINED 75% OF 28 DAY DESIGN STRENGTH.
- 12. NORTH ARROW SHOWN ON PLANS REFERS TO TRUE NORTH. CONTRACTOR SHALL VERIFY TRUE NORTH AND INFORM CONSTRUCTION MANAGER OF ANY DISCREPANCIES BEFORE STARTING CONSTRUCTION.

REFER TO E-I SHEET FOR SITE ELECTRICAL DIAGRAM, DETAILS AND LAYOUT

BUILDING / SHELTER FOUNDATION DESIGN IS UNDER SEPERATE CONTRACT BY OTHERS AND IS EXCLUDED FROM THESE DESIGN DRAWINGS, REFER TO OWNER PROVIDED DRAWINGS FOR SPECIFIC DETAILS REGARDING FOUNDATION SYSTEM.

MONOPOLE / TOWER FOUNDATION DESIGN IS UNDER SEPERATE CONTRACT BY OTHERS AND IS EXCLUDED FROM THESE DESIGN DRAWINGS, REFER TO OWNER PROVIDED DRAWINGS OF FOR SPECIFIC DETAILS REGARDING FOUNDATION SYSTEM.

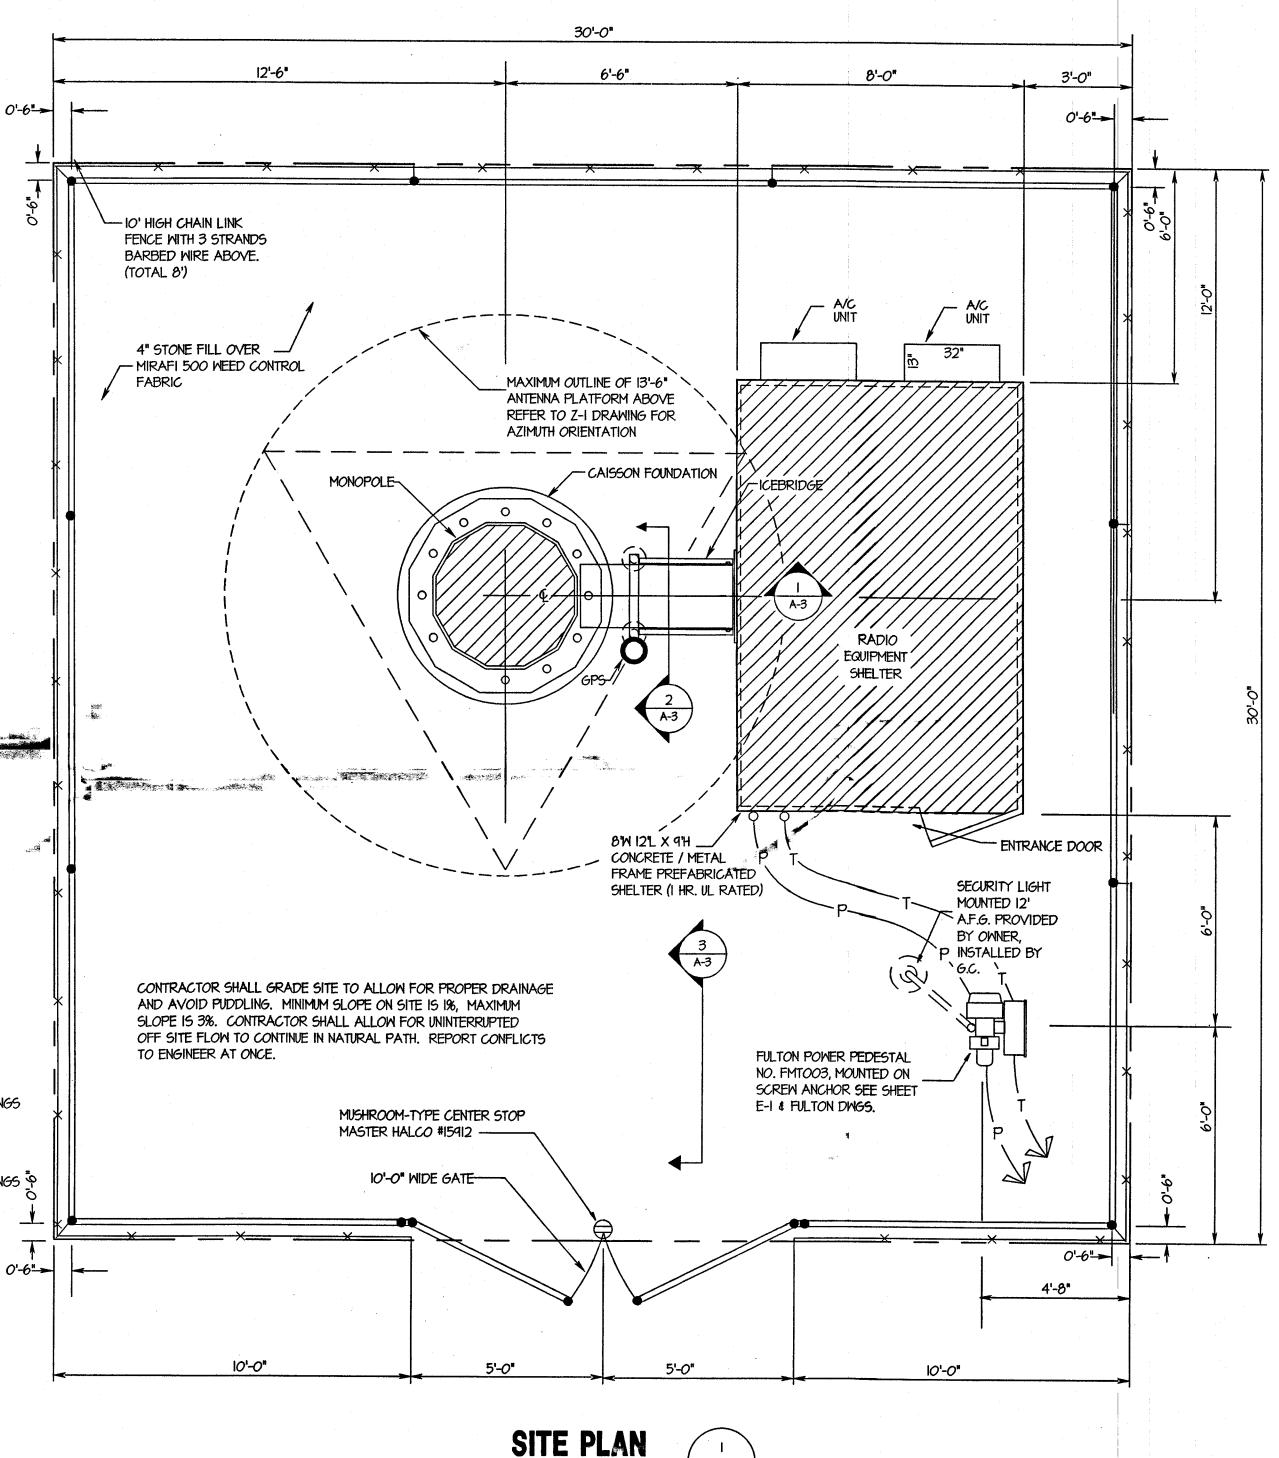

SCALE:3/8"=1'-0"



ONE PIERCE PLACE SUITE 1100 ITASCA, ILLINOIS 60143 OFFICE: (630) 773-1600 FAX: (630) 285-1580

	APPROVALS		
PRIME	co		
LANDL	ORD		
LEASIN	lG		
R.F	· · · · · · · · · · · · · · · · · · ·		
ZONING	a		
CONST	RUCTION		
BSIE_			
FIXNET			

PROJECT NO: T97176

CDG

DRAWN BY:

FOR ZONING



1 07-10-97

W-T ENGINEERING, INC.

CONSULTING ENGINEERS
39 EAST SCULLY DRIVE
SCHAUMBURG, ILLINOIS 60193
ph. (847) 895-3640
fax. (847) 895-9985

CGB 3617-2 DECATUR N.E.


2205 BRUSH COLLAGE RD. DECATUR, ILLINOIS


SHEET TITLE


SITE PLAN & PROJECT NOTES


SHEET NUMBER

A-1

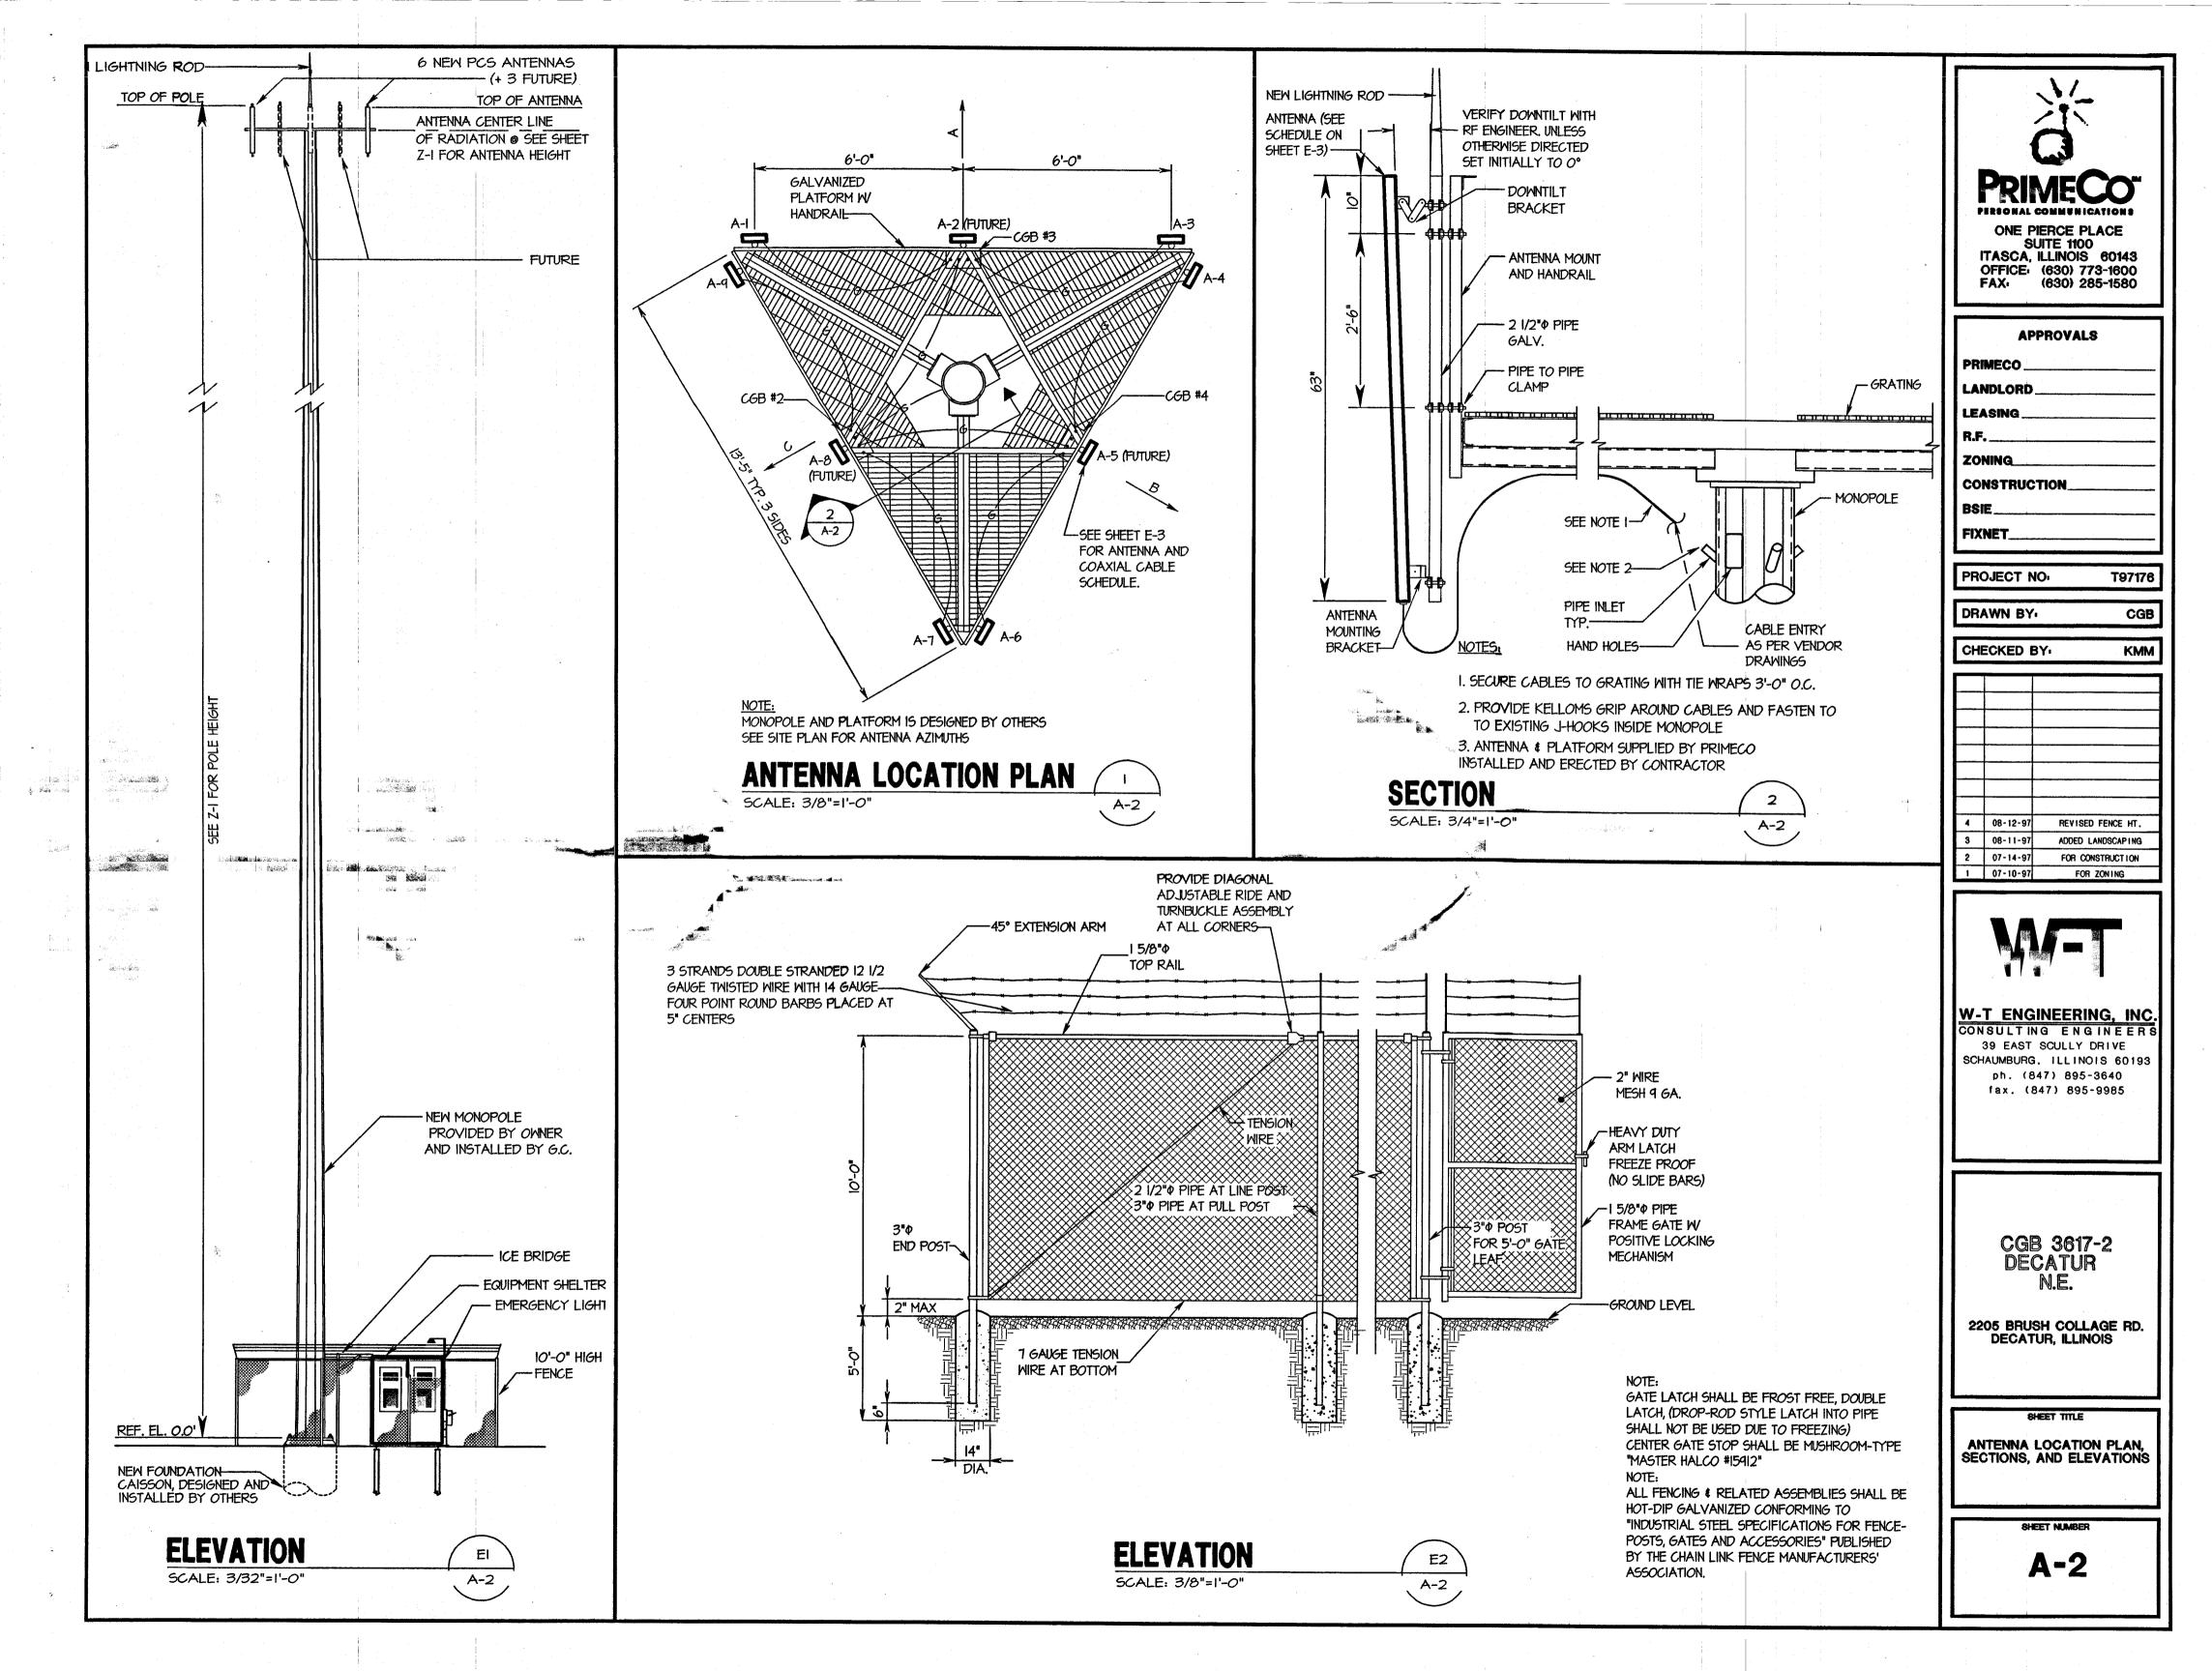

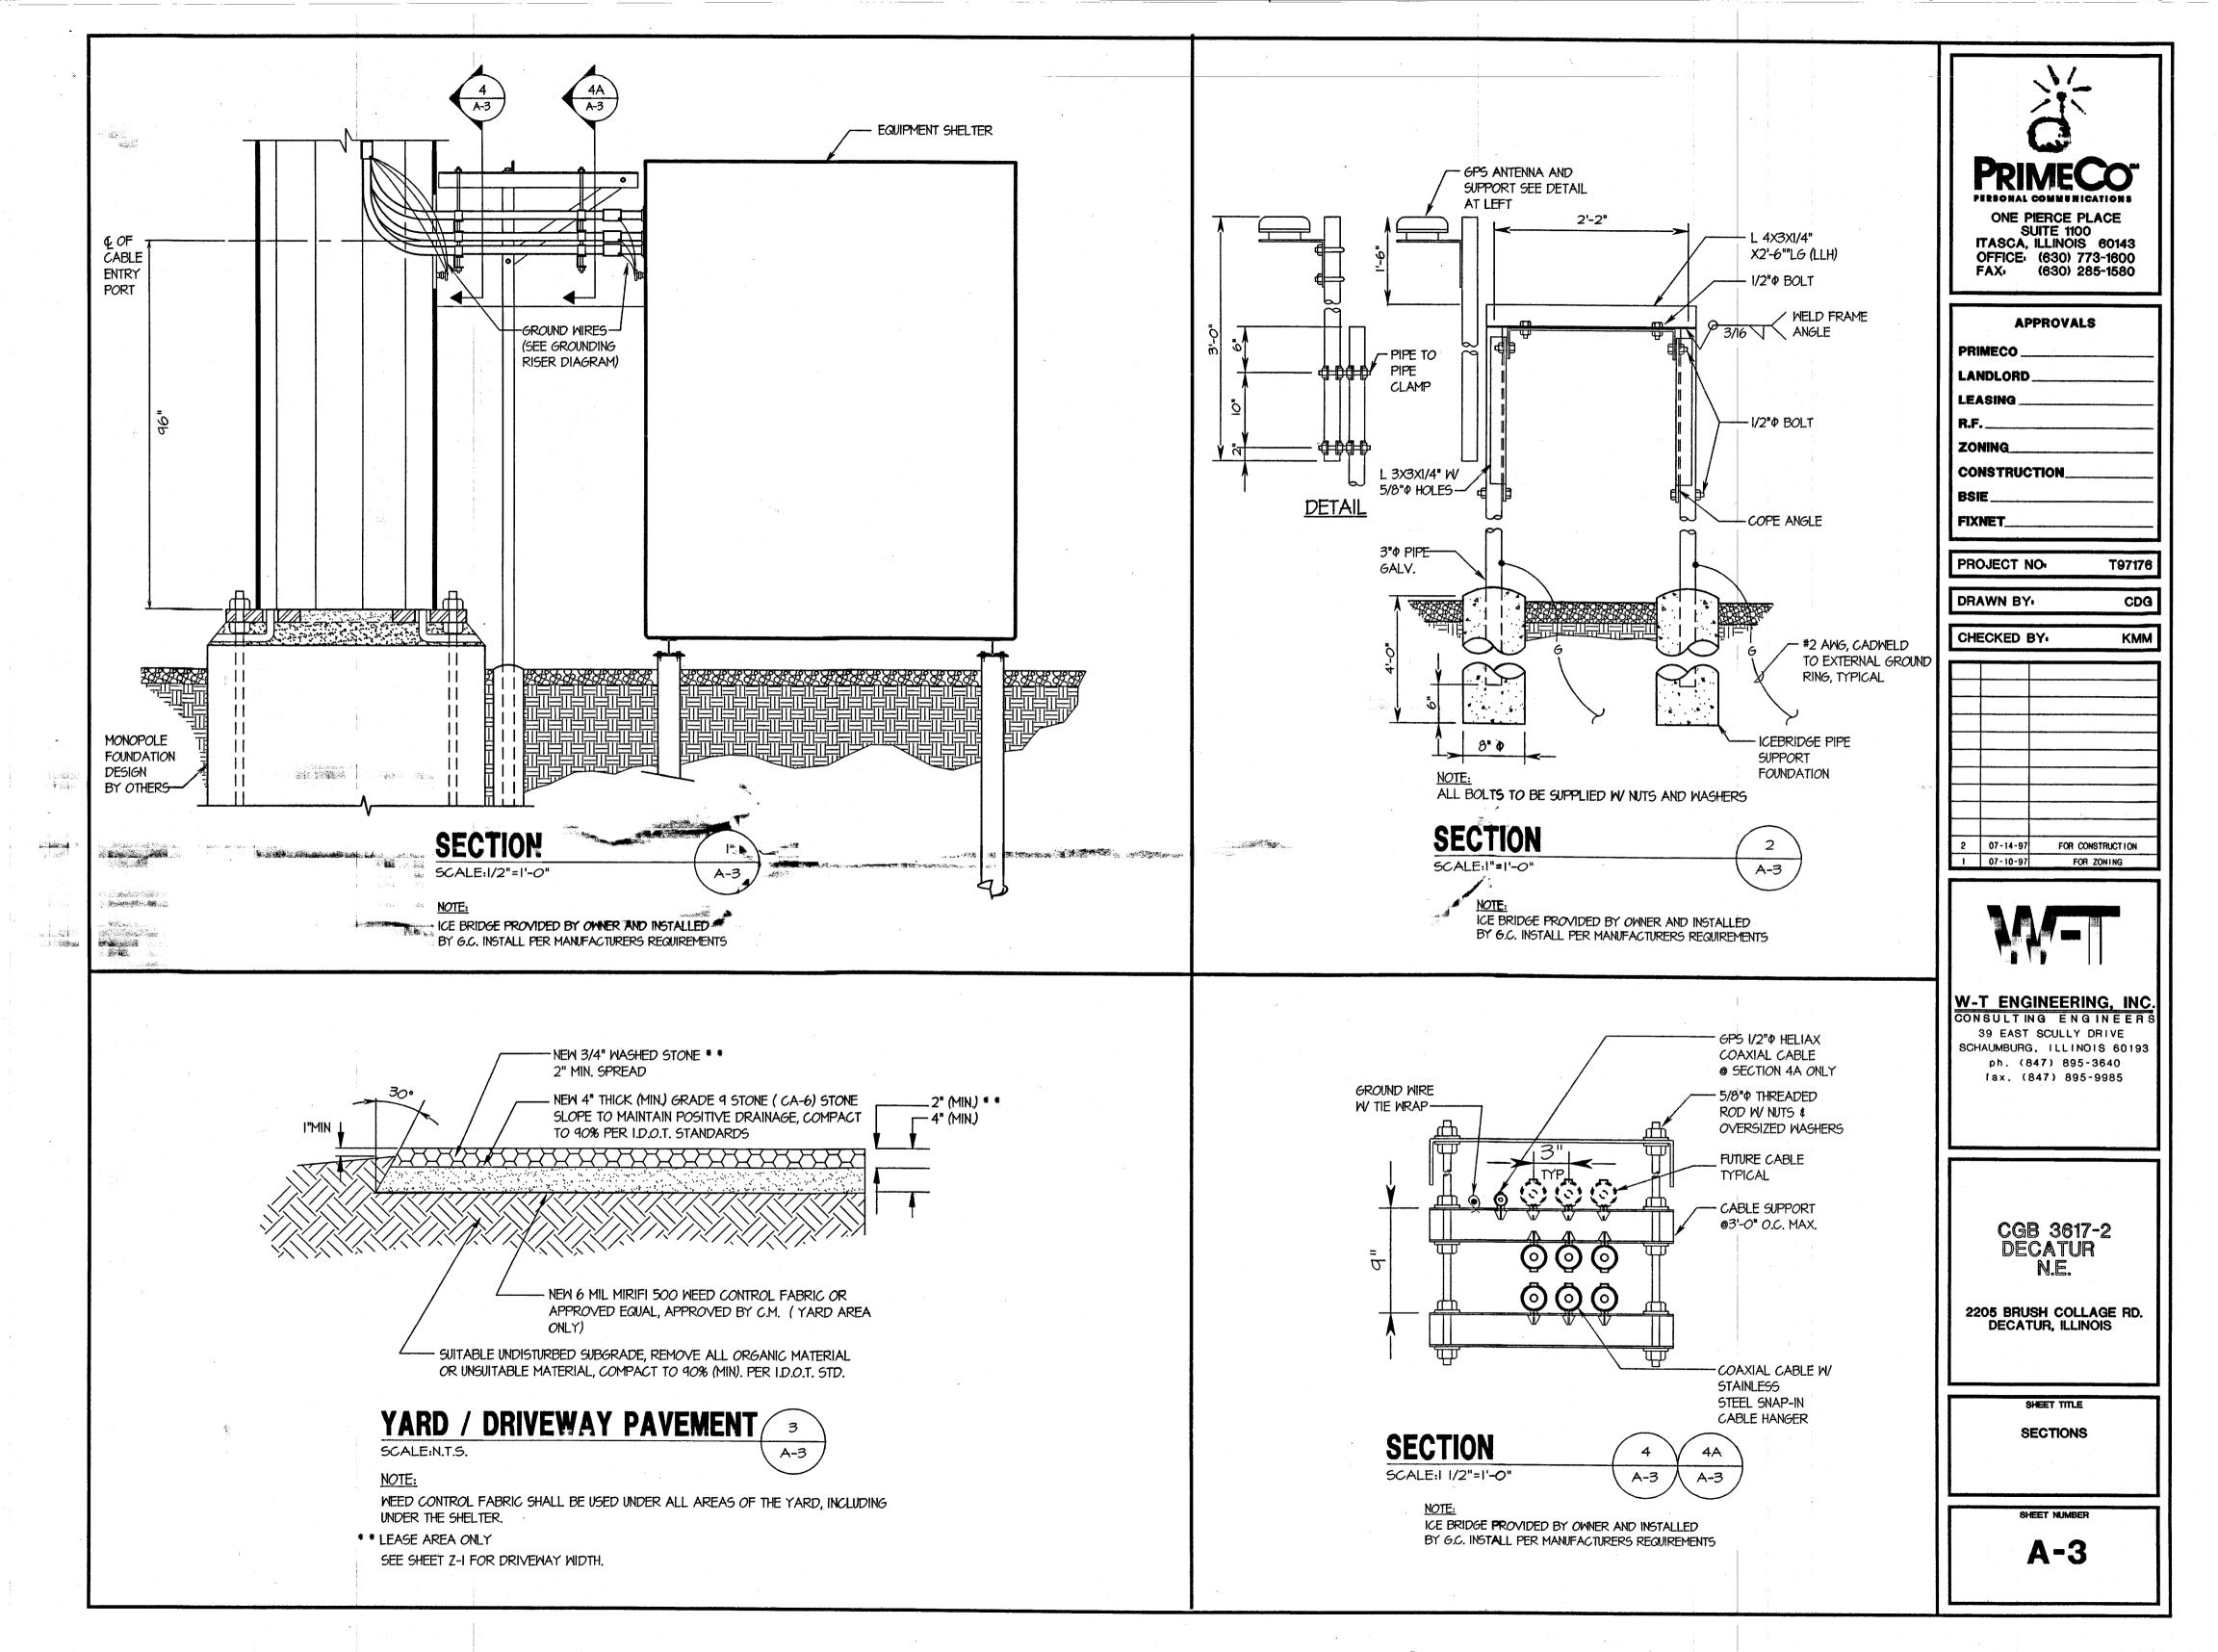

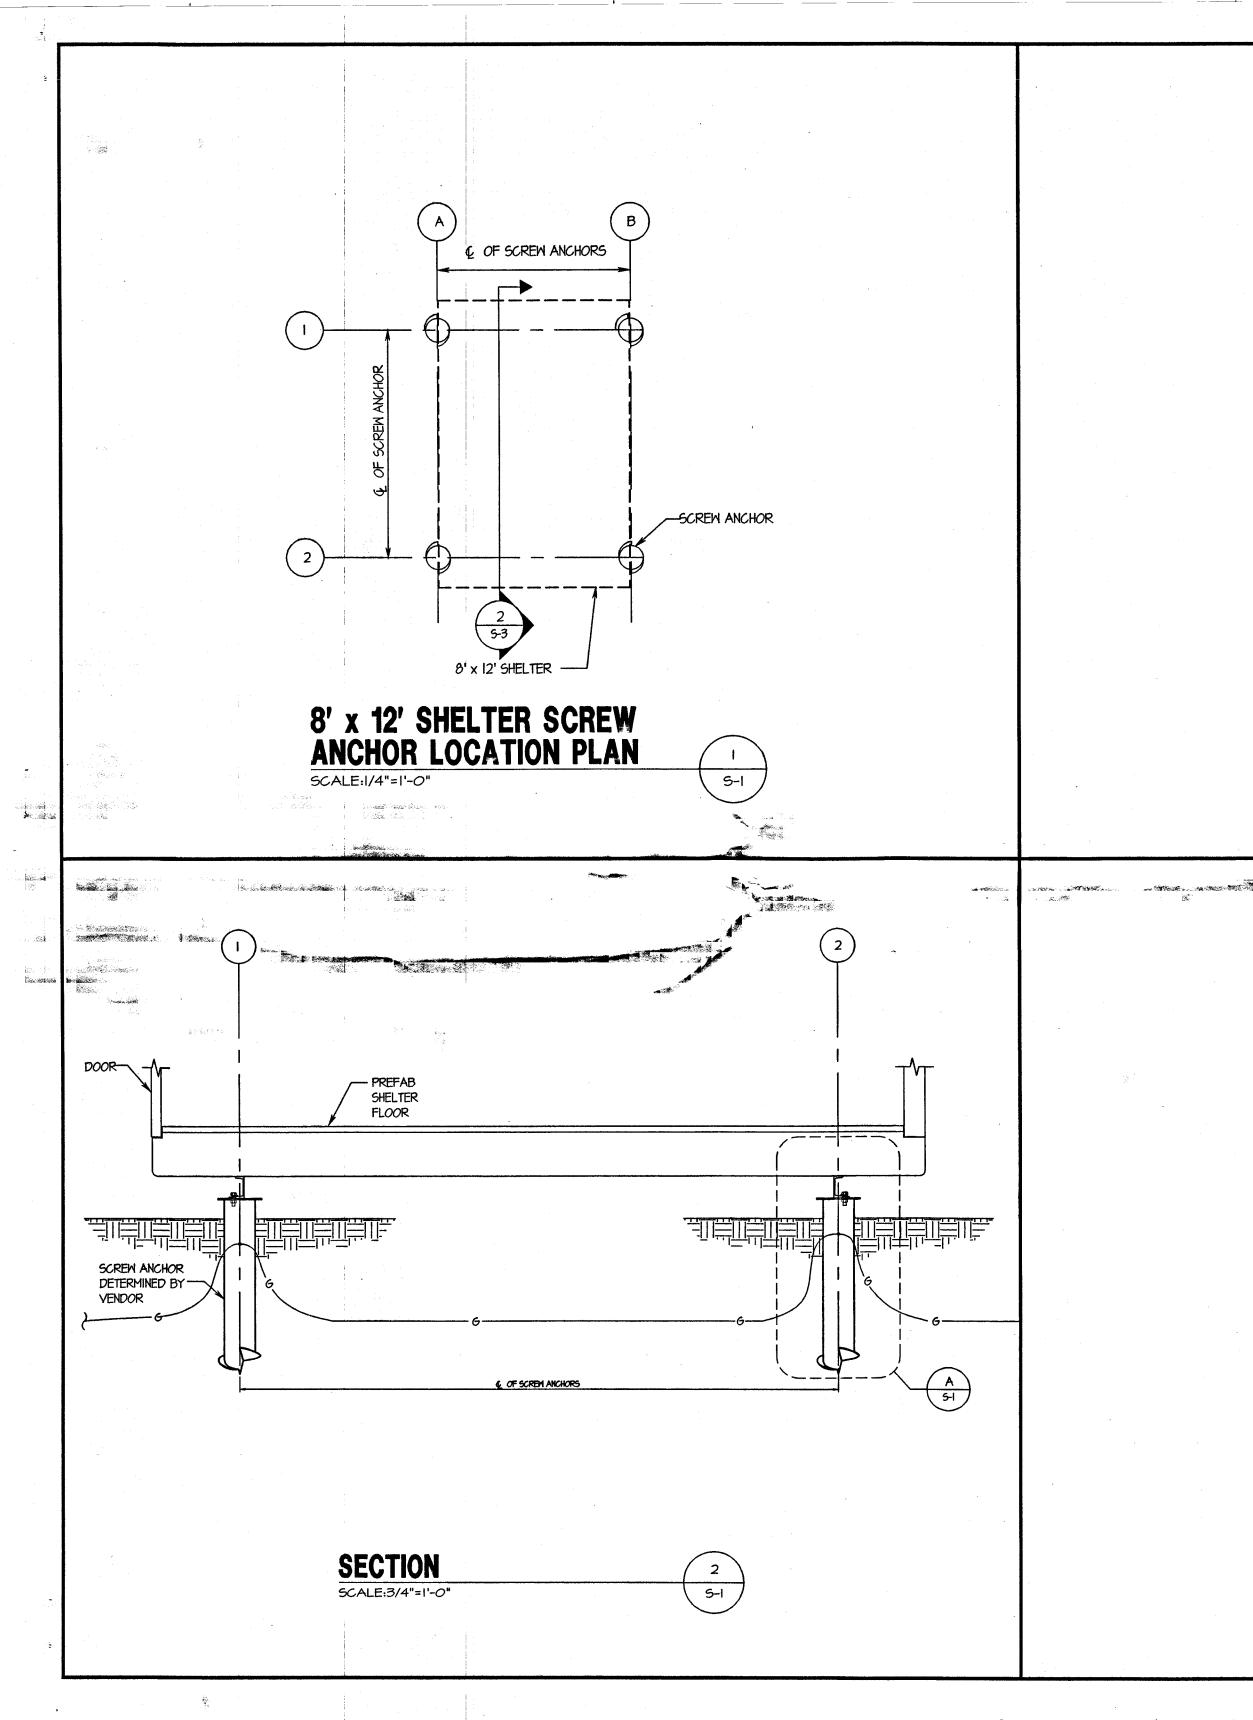

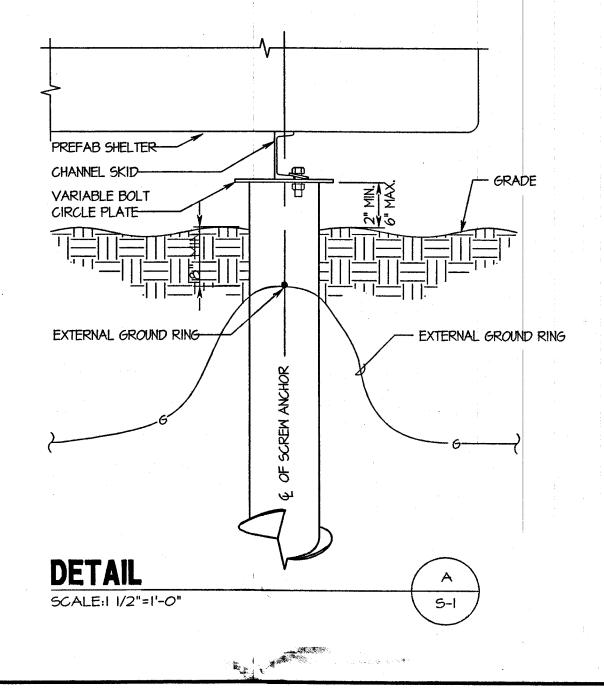

GENERAL NOTES

- I. FOUNDATION SHOWN IS FOR REFERENCE ONLY REFER TO STRUCTURAL DRAWING PROVIDED UNDER SEPERATE COVER BY OTHERS.
- 2. EXACT FOUNDATION SPECIFICATION AND ANCHOR BOLT LAYOUT SHALL BE COORDINATED WITH SHELTER MANUFACTURER.



ONE PIERCE PLACE SUITE 1100 ITASCA, ILLINOIS 60143 OFFICE: (630) 773-1600 FAX: (630) 285-1580

APPRO	VALS
PRIMECO	
LANDLORD	
LEASING	
R.F	
ZONING	
CONSTRUCTION	N
BSIE	
FIXNET	

DRAWN BY: CGB

CHECKED BY: KMM

2 07-14-97 FOR CONSTRUCTION
1 07-10-97 FOR ZONING



W-T ENGINEERING, INC

CONSULTING ENGINEERS
39 EAST SCULLY DRIVE
SCHAUMBURG, ILLINOIS 60193
ph. (847) 895-3640
fax. (847) 895-9985

CGB 3617-2 DECATUR N.E.


2205 BRUSH COLLAGE RD. DECATUR, ILLINOIS


SHEET TITL

SECTIONS AND DETAILS FOR 8'X12' SCREW ANCHOR FOUNDATION

SHEET NUMBER

S-1

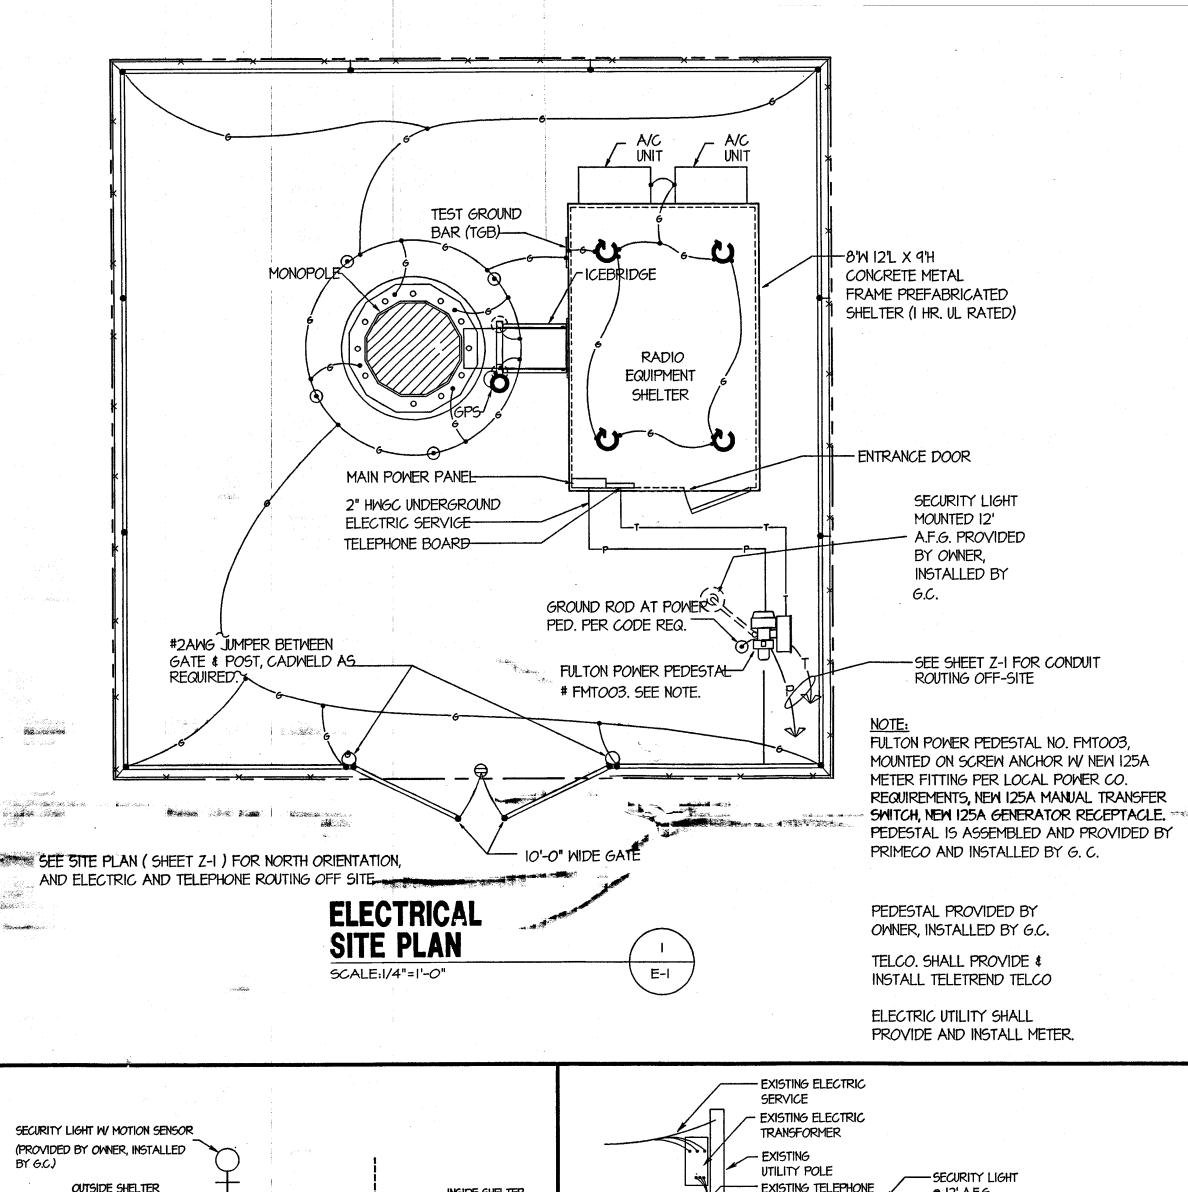

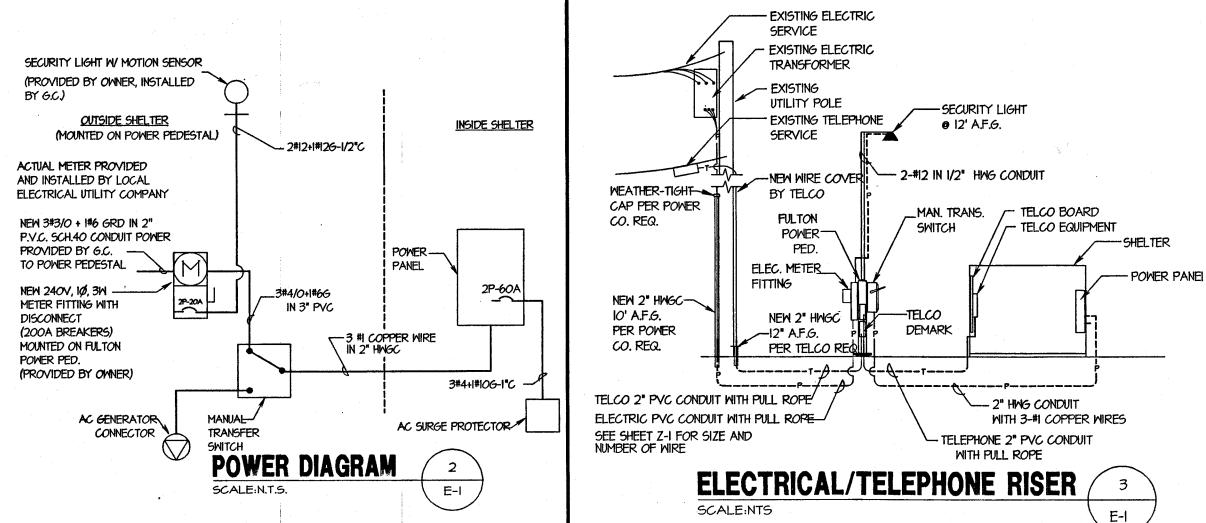

LEGEND

Lh	SAFETY DISCONNECT SWITCH, SIZED AS NOTED	A	AMPERE
	PANELBOARD	v	VOLT
None of a contract of the cont	I ALLEONO	M	WIRE
\bigcirc	KILOWATT HOUR METER	c	CONDUIT
T	TRANSFORMER	6	GROUND
		P	POLE
	CIRCUIT BREAKER	SPGB	SURGE PROTECTOR GROUND BAR
9	LIGHTING FIXTURE, SIZE AS NOTED		(1/4"x2"x24")
		CGB	COLLECTOR GROUND BAR (1/4"x4"x12
0000	COPPER GROUND BAR, SIZED AS NOTED	E6B	EXTERNAL GROUND BAR (1/4"x8"x24"
•	EXOTHERMIC WELD CONNECTION	MGB	MASTER GROUND BAR (I/4"x8"x24")
0	COMPRESSION FITTING GROUND CONNECTION		
. 0	COAXIAL CABLE GROUND CONNECTION	IGR	INTERNAL GROUND RING ("HALO" GROUND)
\odot	GROUND TEST PIT	EGR	EXTERNAL GROUND RING
\odot	GROUND ROD	ACU	AIR CONDITIONER UNIT
— Р—	POWER WIRING, SIZED AS NOTED		
— T —	TELCO WIRING, SIZED AS NOTED	O	FULTON SCREW ANCHOR
<u> </u>	GROUND WIRING, SIZED AS NOTED		
		i i	

ELECTRICAL NOTES

- I. ALL ELECTRICAL WORK SHALL CONFORM TO THE NATIONAL ELECTRICAL CODE (EDITION ACCEPTED BY LOCAL JURISDICTION) AND APPLICABLE LOCAL CODES.
- 2. GROUNDING SHALL COMPLY WITH ARTICLE 250 OF THE NATIONAL ELECTRICAL CODE.
- 3. ALL ELECTRICAL ITEMS SHALL BE U.L. APPROVED OR LISTED.
- 4. WIRES AND CABLES FOR POWER AND LIGHTING SHALL BE COPPER WITH TYPE XHHW, THWN, OR THHN INSULATION. SOLID CONDUCTORS FOR #10 AWG AND SMALLER, STRANDED FOR LARGER THAN #10 AWG. MINIMUM SIZE #12 AWG.
- 5. WIRES AND CABLES FOR POWER AND LIGHTING SHALL BE INSTALLED IN GALVANIZED RIGID STEEL CONDUIT OR FLEXIBLE LIQUIDTIGHT CONDUIT AS INDICATED ON DRAWING.
- 6. CONTRACTOR TO OBTAIN ALL PERMITS, PAY PERMIT FEES, AND BE RESPONSIBLE FOR SCHEDULING INSPECTIONS.
- 7. CONTRACTOR TO OBTAIN LOCAL POWER AND TELEPHONE COMPANY APPROVAL AND COORDINATE WITH UTILITY COMPANIES SERVICE ENTRANCE REQUIREMENTS.
- 8. PROVIDE ALL LABOR AND MATERIAL DESCRIBED ON THIS DRAWING, AND ALL ITEMS INCIDENTAL TO COMPLETING AND PRESENTING THIS PROJECT AS FULLY OPERATIONAL.
- 9. GROUNDING CONNECTIONS SHALL BE EXOTHERMIC TYPE ("CADWELD") TO ANTENNA MASTS, FENCE POSTS, MONOPOLE, AND THE GROUND RODS. REMAINING GROUNDING CONNECTIONS SHALL BE COMPRESSION FITTINGS.
- IO. GROUND COAXIAL CABLE SHIELDS AT BOTH ENDS WITH ANDREWS COAX CABLE GROUNDING KITS
- II. ROUTE GROUNDING CONDUCTORS ALONG THE SHORTEST AND STRAIGHTEST PATH POSSIBLE, EXCEPT AS OTHERWISE INDICATED. GROUNDING LEADS SHOULD NEVER BE BENT AT RIGHT ANGLE, ALWAYS MAKE AT LEAST 12" RADIUS BENDS. #6 WIRE CAN BE BENT AT 6" RADIUS WHEN NECESSARY.
- 12. CONTRACTOR TO PROVIDE GROUND RODS AND GROUND RING AS SHOWN ON ELECTRICAL SITE PLAN AND GROUNDING RISER DIAGRAM. CONTRACTOR SHALL TEST AND VERIFY THAT THE IMPEDANCE DOES NOT EXCEED 5 OHMS TO GROUND BY MEANS OF A BIDDLE-MEGGER TESTER. GROUNDING AND OTHER OPERATIONAL TESTING SHALL SHALL BE WITNESSED BY THE OWNER'S REPRESENTATIVE.
- 13. CONTRACTOR TO PROVIDE 2" SCHEDULE 40 PVC UNDERGROUND CONDUIT WITH PULL WIRE BETWEEN TELEPHONE COMPANY DEMARCATION POINT AND TELCO LINE BOX ON POWER PEDESTAL. CONTRACTOR SHALL PROVIDE 2" HWGC FROM POWER PEDESTAL TO SHELTER WITH PENETRATION FITTING.
- 14. CONTRACTOR TO PROVIDE 2" SCHEDULE 40 PVC UNDERGROUND CONDUIT WITH PULL WIRE BETWEEN ELECTRICAL UTILITY COMPANY DEMARCATION POINT AND KWH METER BASE ON POWER PEDESTAL. CONTRACTOR SHALL PROVIDE 2" HWGC FROM POWER PEDESTAL TO SHELTER WITH PENETRATION FITTING.
- 15. NOTIFY J.J.L.I.E. (1-800-892-0123) PRIOR TO ANY EXCAVATION.
- 16. CONTRACTOR TO PROVIDE GROUND INSPECTION WELL. REFER TO APPROPRIATE DETAIL ON DRAWING E-3.
- IT. GROUNDING CONDUCTORS SHALL BE COPPER ONLY. ABOVE GROUND EITHER SOLID OR STRANDED CONDUCTORS ARE PERMITTED. IGR AND ALL EXTERNAL CONDUCTORS (WITH THE EXCEPTION FOR GROUND WIRE BETWEEN THE TOP AND THE BOTTOM OF THE ANTENNA TOWER) MUST BE BARE. EQUIPMENT GROUND LEADS IN CABLE TRAYS MUST BE GREEN INSULATED. BELOW GROUND BARE SOLID TINNED WIRE SHALL BE USED. ALL WIRES MUST BE #2 AWG MIN. WITH THE EXCEPTION OF GROUND WIRES FOR MISCELLANEOUS METALLIC OBJECTS IN THE EQUIPMENT SHELTER, WHERE #6 AWG WIRES CAN BE USED.
- 18. THE GROUND ELECTRODE SYSTEM SHALL CONSIST OF DRIVEN GROUND RODS UNIFORMLY SPACED AROUND CELL SITE. THE GROUND RODS SHALL BE 5/8"x8'-0" COPPER CLAD STEEL. THE RODS SHALL BE INTERCONNECTED WITH #2 AWG BARE SOLID TINNED COPPER GROUND WIRE BURIED 30" BELOW THE SURFACE OF THE SOIL. MINIMUM DISTANCE BETWEEN GROUND RODS 8', MAXIMUM 16'



ONE PIERCE PLACE SUITE 1100 ITASCA, ILLINOIS 60143 OFFICE: (630) 773-1600 FAX: (630) 285-1580

	PPROVALS
PRIMECO.	
LANDLORI	D
LEASING_	·
R.F	·
ZONING_	·
CONSTRU	CTION
BSIE	-h
FIXNET	

DRAWN BY	CDG	
CHECKED BY	KMM	

T97176

PROJECT NO

-		
		•.
2	07-14-97	FOR CONSTRUCTION
1	07-10-97	FOR ZONING



W-T ENGINEERING, INC.
CONSULTING ENGINEERS
39 EAST SCULLY DRIVE
SCHAUMBURG. ILLINOIS 60193
ph. (847) 895-3640
fax. (847) 895-9985

CGB 3617-2 DECATUR N.E.


2205 BRUSH COLLAGE RD. DECATUR, ILLINOIS


SHEET TIT

ELECTRICAL PLAN, RISER, NOTES AND DETAILS

SHEET NUMBER


E-1

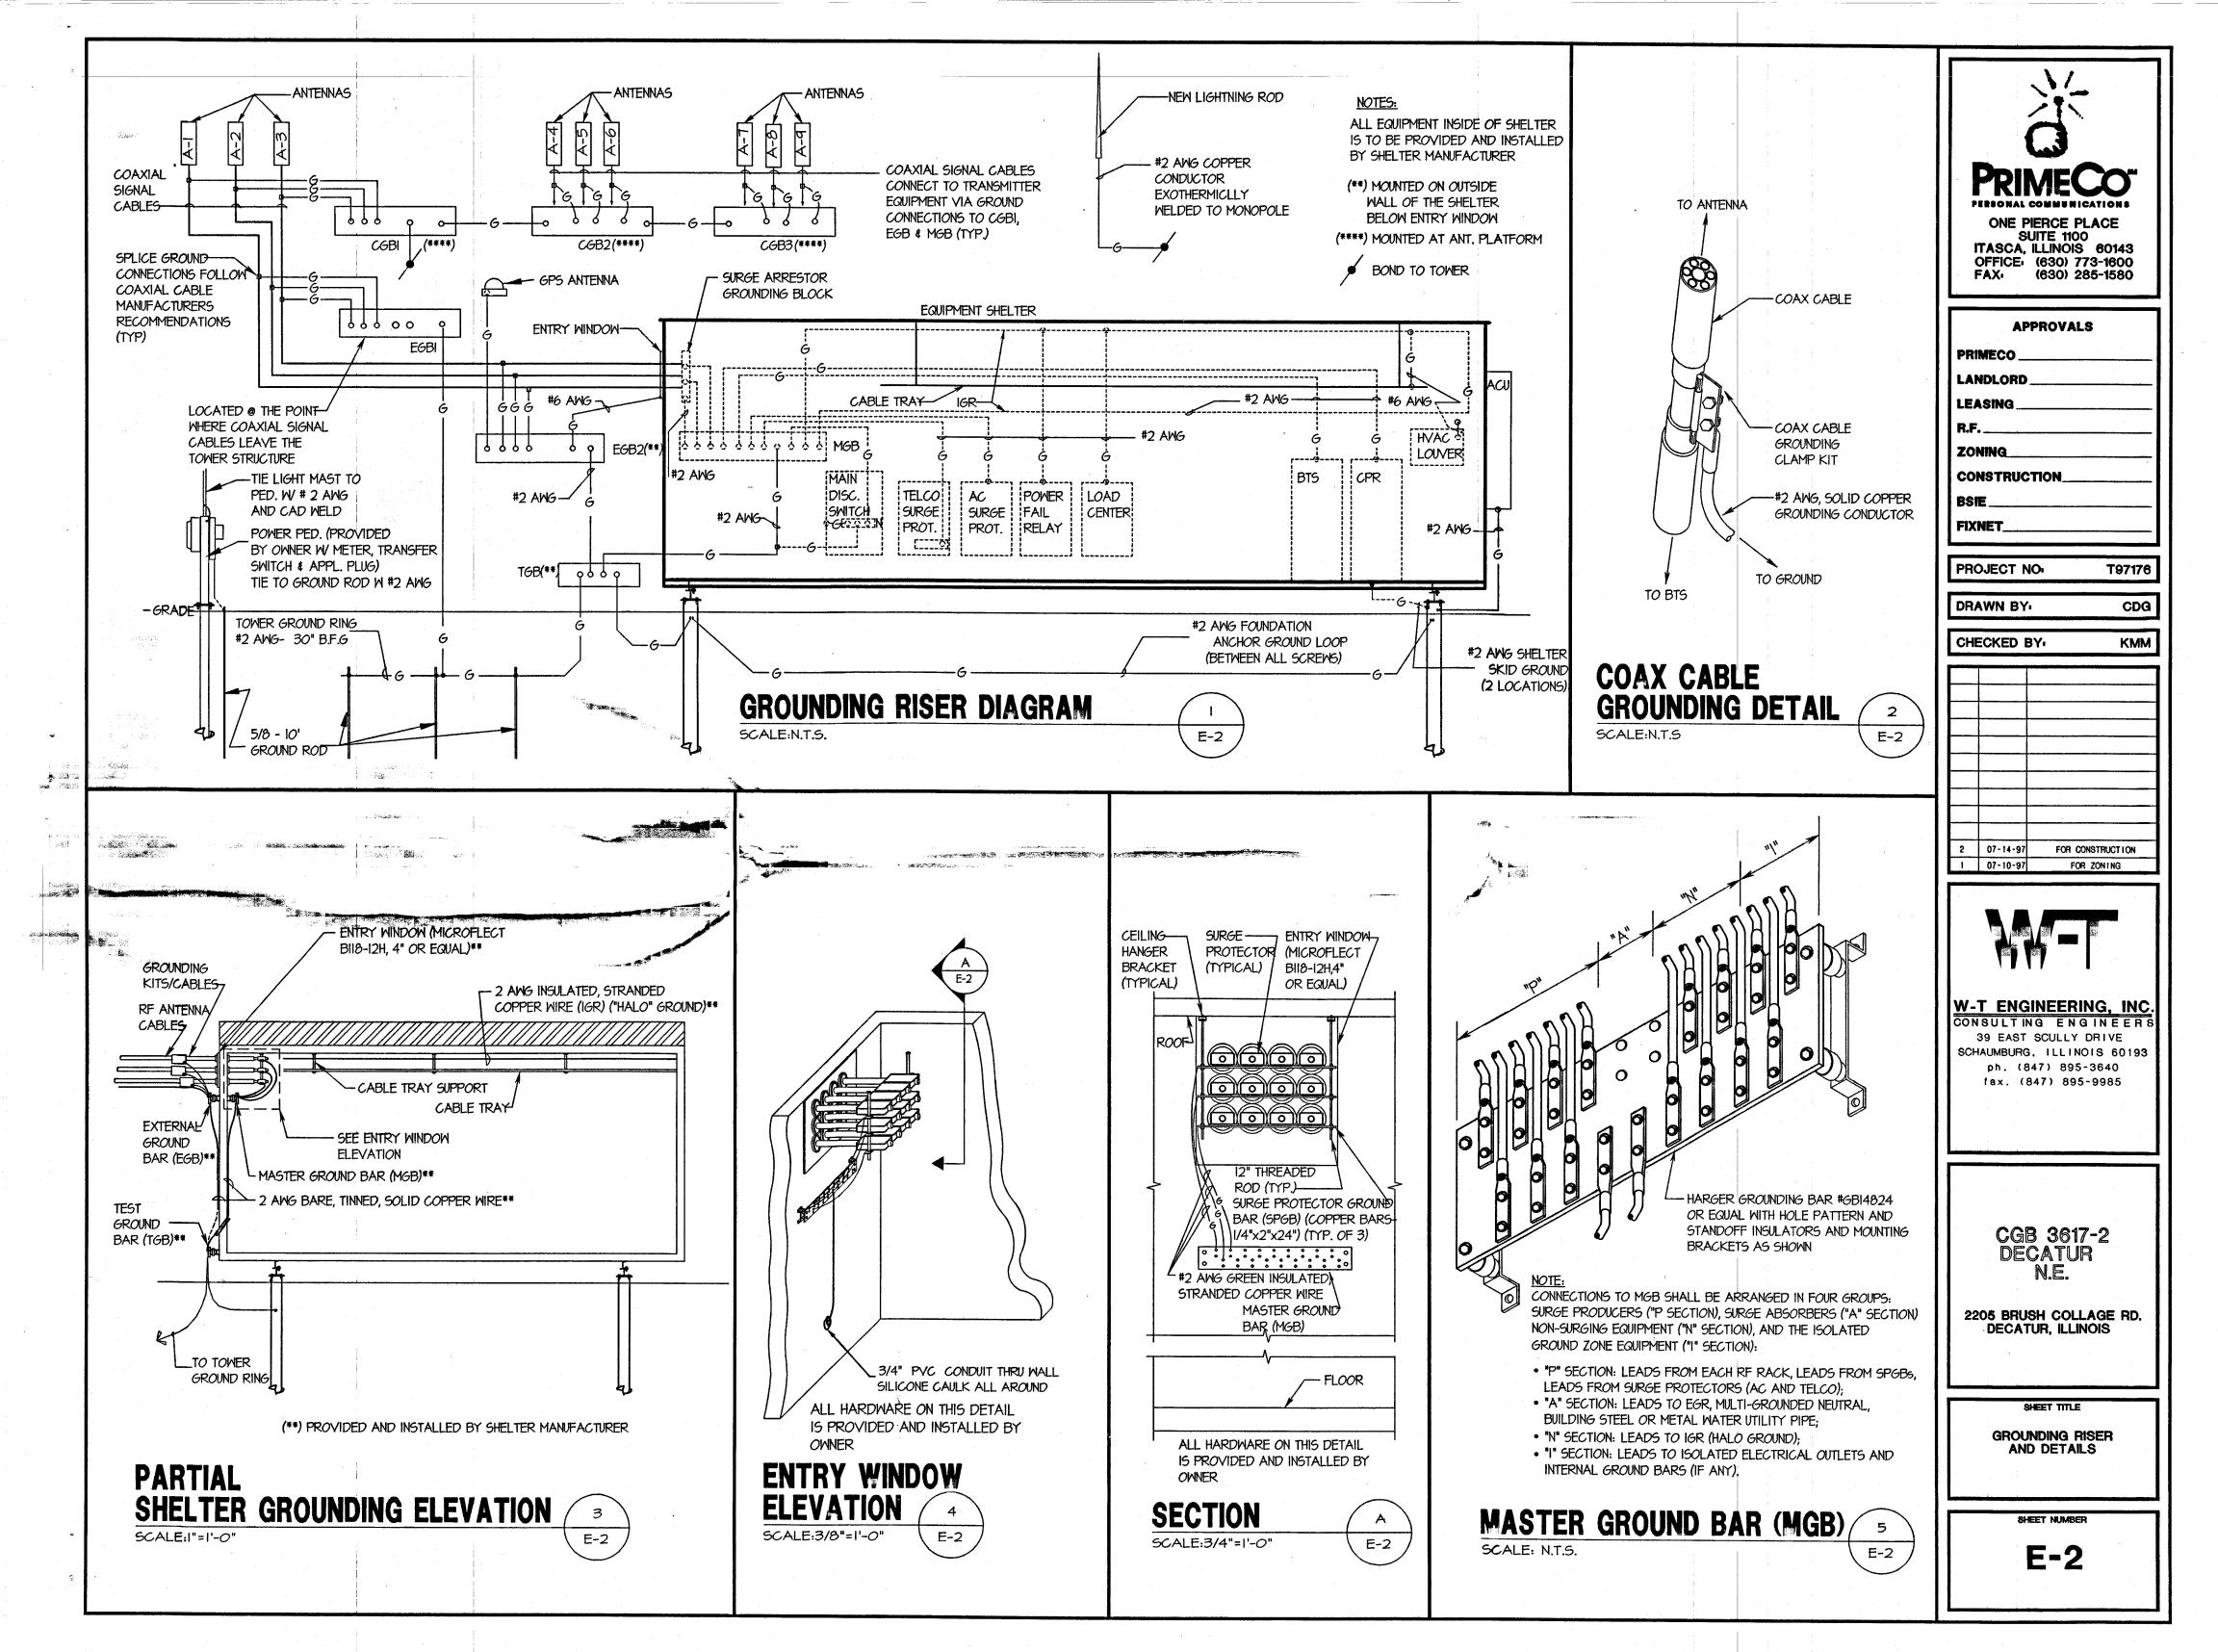

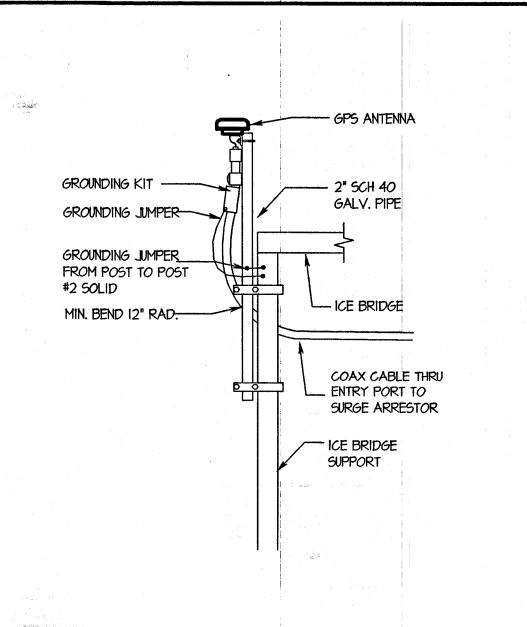

GPS ANTENNA MOUNT DETAIL (ICE BRIDGE) SCALE:1/2"=1'-O"

FROM EGB2-

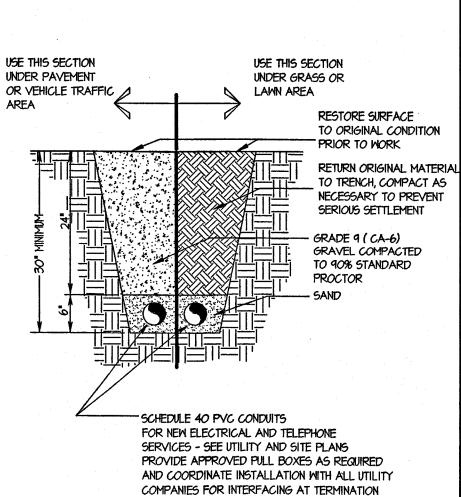

BURIED	CABLE	DETAIL	2
SCALE: N.T.S.	-		E-3

E-3

HARGER GROUNDING BAR

PROVIDED WITH SHELTER

#GBII44I2G OR EQUAL


POINTS. PROVIDE FULL LENGTH PULL ROPES (TYP)


	(A	NTENNA ANI	D COA	XIAL	CABI	E SC	HEDUL	E
ANTENNA MARK	SECTOR	ANTENNA .	COAXIAL CABLE FEED LOCATION	DOWN-TILT	AZIMUTH	ANTENNA & HEIGHT	COAXIAL CABLE MARK	COAXIAL CABLE
A-I	1	ALLEN TELECOM DB980H90E (63"x 6.3"x 2")	ВОТТОМ	SEE NOTE I.	SEE NOTE 3.	SEE NOTE 2.	C-I	SEE NOTE 4.
A-2	1	-FUTURE-						
A-3	l	ALLEN TELECOM DB980H90E (63"x 6.3"x 2")	<i>вотто</i> м	SEE NOTE I.	SEE NOTE 3.	SEE NOTE 2.	C-3	SEE NOTE 4.
A-4	2	ALLEN TELECOM DB980H90E (63"x 6.3"x 2")	ВОТТОМ	SEE NOTE I.	SEE NOTE 3.	SEE NOTE 2.	C-4	SEE NOTE 4.
A-5	2	-FUTURE-						
A-6	2	ALLEN TELECOM DB980H90E (63"x 6.3"x 2")	ВОТТОМ	SEE NOTE I.	SEE NOTE 3.	SEE NOTE 2.	C-6	SEE NOTE 4.
A-7	3	ALLEN TELECOM DB980H90E (63"x 6.3"x 2")	ВОТТОМ	SEE NOTE I.	SEE NOTE 3.	SEE NOTE 2.	C-7	SEE NOTE 4.
A-8	3	-FUTURE-						
A-9	3	ALLEN TELECOM DB980H90E (63"x 6.3"x 2")	ВОТТ <i>О</i> М	SEE NOTE I.	SEE NOTE 3.	SEE NOTE 2.	C-9	SEE NOTE 4.

COAX CAE	BLE CHART
COAX CABLE LENGTH	CABLE TYPE AND DIAMETER
I. LESS THAN 65'	HELIAX 1/8"\$ LDF5-50A
2. 65' TO 130'	HELIAX I 1/4"0 LDF6-50
3. 130' TO 225'	HELIAX I 5/8*0 LDF7-50A
4. MORE THAN 225'	HELIAX 2 1/4"¢ LDF12-50
·	

NOTES

- I. ALL ANTENNAS TO BE FURNISHED WITH DOWNTILT BRACKETS.
 CONTRACTOR TO COORDINATE REQUIRED MECHANICAL
 DOWNTILT FOR EACH ANTENNA WITH RF ENGINEER.
- 2. ANTENNA CENTERLINE HEIGHT IS IN REFERENCE TO ELEVATION O.O'.
 ANTENNA HEIGHTS ARE SHOWN ON TOWER ELEVATION SHEET Z-2
- 3. ANTENNA AZIMUTHS SHOWN ON SITE PLAN. SHEET Z-I
- 4. SEE COAX CABLE CHART AT LEFT FOR CABLE DIAMETERS.
- 5. CHECK WITH RF ENGINEER FOR LATEST ANTENNA TYPE & AZIMUTH.
- 6. CONTRACTOR SHALL VERIFY ANTENNA TYPE AND AZIMUTH WITH CONSTRUCTION MANAGER PRIOR TO CONSTRUCTION.

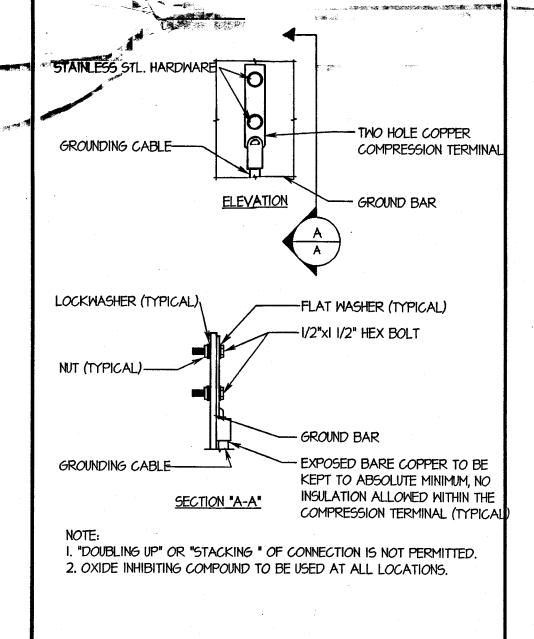

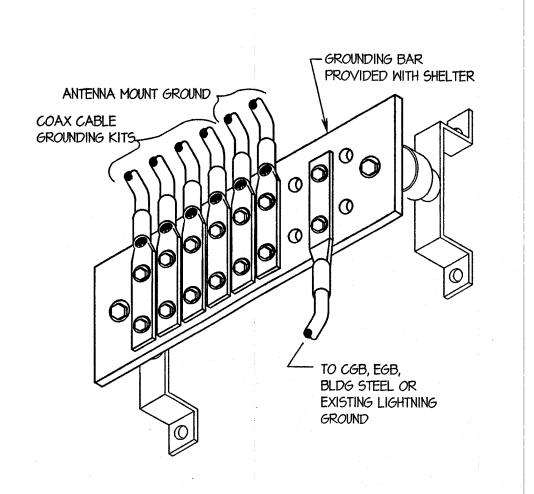

COLLECTOR GROUND BAR (CGB)
SCALE: N.T.S.

PRIMECO
PERSONAL COMMUNICATIONS
ONE PIERCE PLACE
SUITE 1100
ITASCA, ILLINOIS 60143
OFFICE: (630) 773-1600
FAX: (630) 285-1580

APPROVALS

PRIMECO
LANDLORD

LEASING

R.F.

ZONING

CONSTRUCTION

BSIE

FIXNET

PROJECT NO: T97176

DRAWN BY: CDG

CHECKED BY: KMM

2 07-14-97 FOR CONSTRUCTION
1 07-10-97 FOR ZONING



W-T ENGINEERING, INC.

39 EAST SCULLY DRIVE SCHAUMBURG, ILLINOIS 60193 ph. (847) 895-3640 fax. (847) 895-9985

> CGB 3617-2 DECATUR N.E.


2205 BRUSH COLLAGE RD. DECATUR, ILLINOIS

SHEET TITL

ELEVATIONS, AND ANTENNA SCHEDULE

SHEET NUMBER

E-3

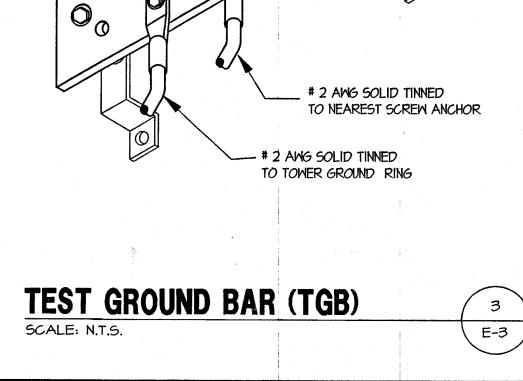

TYPICAL GROUND BAR CONNECTIONS DETAIL
SCALE: N.T.S.

(4 E-3)